
# SALT LAKE CITY CORPORATION

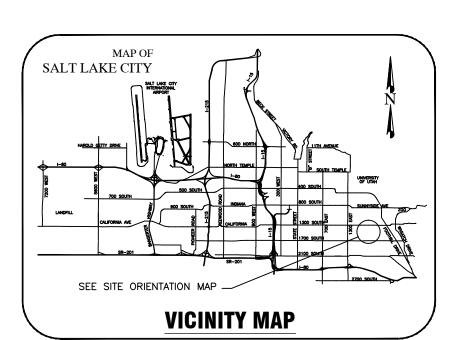

# **OWNER**

# DEPARTMENT OF: **COMMUNITY AND ECONOMIC DEVELOPMENT ENGINEERING DIVISION**

**DIRECTOR - MARY DELAMARE SCHAEFER** CITY ENGINEER - JEFF SNELLING, S.E.

349 SOUTH 200 EAST, SUITE 100 SALT LAKE CITY. UTAH 84111 OFFICE - 801.535.7961 FAX - 801.535.6093

# **CITY OFFICIALS**


	MAYOR	RALPH BECKER
CITY COUNCIL	DIST. 1	JAMES ROGERS
	DIST. 2	KYLE LAMALFA
	DIST. 3	STAN PENFOLD
	DIST. 4	LUKE GARROTT
	DIST. 5	ERIN MENDENHALL
	DIST. 6	CHARLIE LUKE
	DIST. 7	LISA ADAMS

WASATCH HOLLOW PRESERVE
<b>PHASE II RIPARIAN RESTORATION</b>
<b>JOB NO. 231504</b>
1596 SOUTH 1700 EAST

# SHEET SET ASSEMBLY ORDER

<u>SHEET</u> <u>DESIGNATOR</u> GIOO1	BINDING ORDER 1	<u>SHEET</u> <u>TITLE</u> GENERAL INFORMATION COVER SHEET
G1002	2	GENERAL INFORMATION NOTES
LD101	3	LANDSCAPE DEMOLITION PLAN
LS101 - LS103	4 - 6	LANDSCAPE SITE PLAN
LP101 - LP103	7 - 9	LANDSCAPE PLANTING PLAN
LI101 - LI103	10 - 12	LANDSCAPE IRRIGATION PLAN
LS401 LS406	13- 18	LARGE SCALE VIEWS
DT501 - DT507	19 - 26	DETAILS
CI101 - CI102	27 - 28	CIVIL IMPROVEMENT PLAN

<i></i>			
CITY ENGINEER	CITY PROJECT MANAGER	PPL DIRECTOR	OPEN SPACE LANDS PROGRAM MANAGER
JEFF SNELLING, S.E DATE	RON SALISBURY, PLA DATE	TODD REESE, RLA DATE	LEWIS KOGAN D

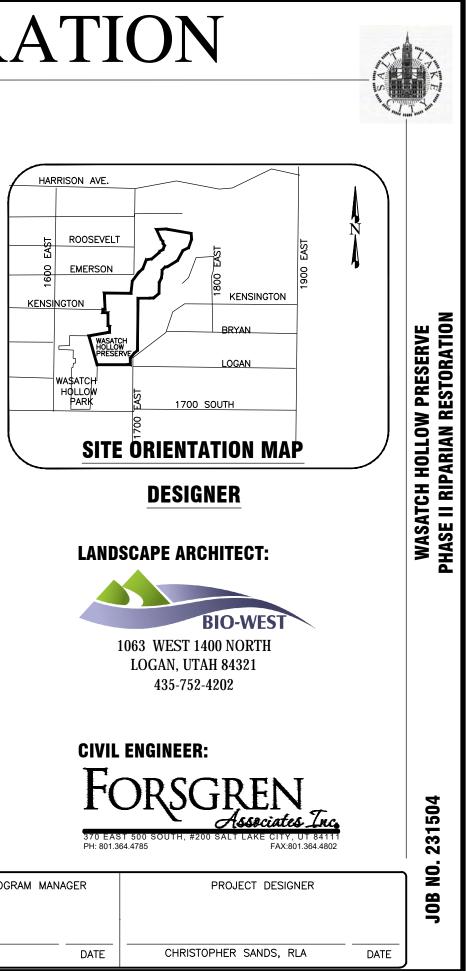

## GENERAL NOTES

### Project Limits

All construction activity shall be confined to the project limit of disturbance (footprint) including any staging/stockpile areas. Do not disturb, excavate or work beyond project limits of disturbance without permission from the Owners Representative.

<u>Site Mapping</u> Basis of bearing for plans is UTM NAD 83 Zone 12N. The base survey was provided by Forsgren Associates, Inc. Verification of survey mapping is the responsibility of the Contractor.

## Survey Staking

Survey staking is the responsibility of the Contractor. The Contractor may obtain CAD files from the Designer for staking and layout purposes.

## Permits

The Contractor is required to comply with all construction related requirements in each permit issued for the project.

## Utilities

Utility locations have not been surveyed. It is the responsibility of the Contractor to perform all utility locations at least 48 hours prior to excavation, call 1(800)662-4111. It is the responsibility of the Contractor to protect all existing sewer, water, gas and electric utilities encountered in the work. Any relocation or improvements of utilities shall be accurately noted on as-built drawings and issued to the Owners Representative at the completion of the project.

## Temporary Construction Facilities

All temporary utilities and facilities will be the responsibility of the Contractor. A construction trailer is not required. Potable water is not available on site and shall be provided by the Contractor. A chemical toilet of suitable type shall be provided and maintained by the Contractor at all times. The Contractor is responsible for job site conditions and the safety for human life during the course of construction. This requirement shall apply continuously during the period of construction and is not limited to normal working hours.

The Contractor shall keep job site area clean, hazard free and dispose of all debris, rubbish and construction waste, and remove all abandoned materials from the site. All disturbed staging and access areas are to be restored to pre-construction condition. The Contractor is responsible to reclaim (regrade, seed and mulch) construction features not specified as remaining on the site and clean up all areas at the completion of the project.

Construction Spoils and Waste Handling Items encountered below grade and not shown on the drawings shall be brought to the attention of the Owners Representative. All construction spoils and waste are the responsibility of the Contractor and shall be disposed of at an approved landfill facility.

## Clearing and Grubbing

Existing on-site materials shall be carefully removed and stored for re-use, or disposed of at an approved landfill facility. All existing vegetation not in designated excavation areas and not designated for removal is to be protected in place. Completely remove stumps, roots, shrubs, weeds, and other debris protruding from the ground in areas to be excavated.

## Site Earthwork and Grading

The Contractor is responsible for all site earthwork and grading activities to meet designs identified in plans and details, which are intended to show final result of design. Modifications may be required to suit job site conditions encountered during construction and shall be included in as-built drawings provided to the Owners Representative at completion of the project.

All stream channel banks affected by construction activities shall be stabilized and protected throughout construction.

Backfill and embankment material shall be composed of suitable excavated soils.

Existing topsoil shall be excavated and salvaged by Contractor for use in landscaping and grading activities. Topsoils used in landscaping shall have acidity range (pH) from 5.5 to 7.5 and a minimum organic content of 3%

Topsoil shall be placed at 80% to 90% maximum dry density and subsoil at 85% minimum compaction as determined by the Standard Proctor Method (ASTM D0698-66T or AASHTO T99). All existing topsoils shall be salvaged and utilized for revegetation activities to the extent possible.

## Site Construction Notes

All tree removal activities and site disturbance activities shall occur only after a Nesting Bird Survey has been conducted within the construction site footprint and all protocols and protective measures are followed.

All planting and seeding activities shall occur during the designated seeding and planting window from September 15 to December 1 unless in areas with irrigation or otherwise authorized by the Owners Representative.

Where ground conditions are damp and equipment traffic would result in excessive ground compaction and rutting, use construction mats to access active work areas.

Use a water truck or other suitable watering device as needed to control dust.

Inspect paved roads adjacent to the project site regularly for mud tracking; sweep roadways as needed and ensure roads are left clean at the end of each shift.

Clean site and dispose of construction waste as permitted.

Temporary Environmental/Safety Fence Install fencing to demarcate active work areas as appropriate based on construction phasing.

The Contractor is responsible to keep access to Private Property open at all times during construction.

The Contractor is responsible for installing water control measures as needed to perform stream work in dry conditions. Water control measures include but are not limited to diversions, culverts, sumps with pumps or other means necessary to divert surface water away from the active work area.

Storm Water Pollution Prevention Plan Notes 1. No earth shall be disturbed until erosion control measures are in place.

2. Erosion control measures will be maintained and remain in place until re-vegetation measures have been established

3. Monitor, inspect, and maintain all erosion control measures as needed to prevent erosion and sediment discharge into creek. Adjust locations of measures and install additional measures as construction phasing requires. Disturbed areas where construction activity has ceased will be stabilized in accordance with State UPDES and Salt Lake City requirements. Submittal of NOI and acquisition of UPDES Storm Water General Permit for Construction Activities (UTR300000) is the responsibility of the Contractor.

4. The Contractor is responsible for implementing and utilizing Best Management Practices (BMPs) to prevent storm water runoff and water pollution during construction activities. The Contractor is responsible for supplying equipment and plans that provide both dust and fire control during project construction. Use caution when working in and around wet areas. If potential hazardous materials are encountered, contact the Owners Representative immediately. Grading And Drainage Plan Notes

1. Contractor to stake the boundary of the grading area for approval from the Owners Representative prior to grading.

2. Contractor is responsible for erosion, dust and temporary drainage control during grading operations.

3. Fill areas are to be compacted throughout to a minimum of 90% relative compaction.

4. Contractor is responsible for the location and protection of all utilities.

5. Export soil, if any, must be transported to a legal landfill or permitted site.

## Landscape Planting Plan Notes

1. The planting plan is diagrammatic. Plant locations are approximate. Exact locations of plant materials to be approved by the Owners Representative in the field prior to installation.

2. All plant material shall conform to the guidelines established by "The American Standard for Nursery Stock". published by the American Association of Nurservmen, Inc.


3. No substitution of plant species will be allowed without the written approval of the Owners Representative.

4. Locate and verify all utility line locations prior to staking and report any conflicts to the Owners Representative.

5. Do not install plant material until the rough grading of topsoil is approved by the Owners Representative.

6. Hand water plant material until established.



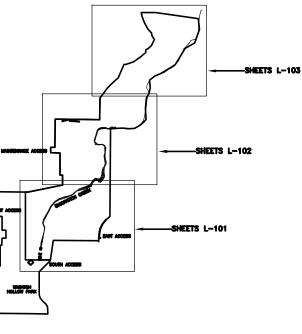

ABBRE\	/IATIONS
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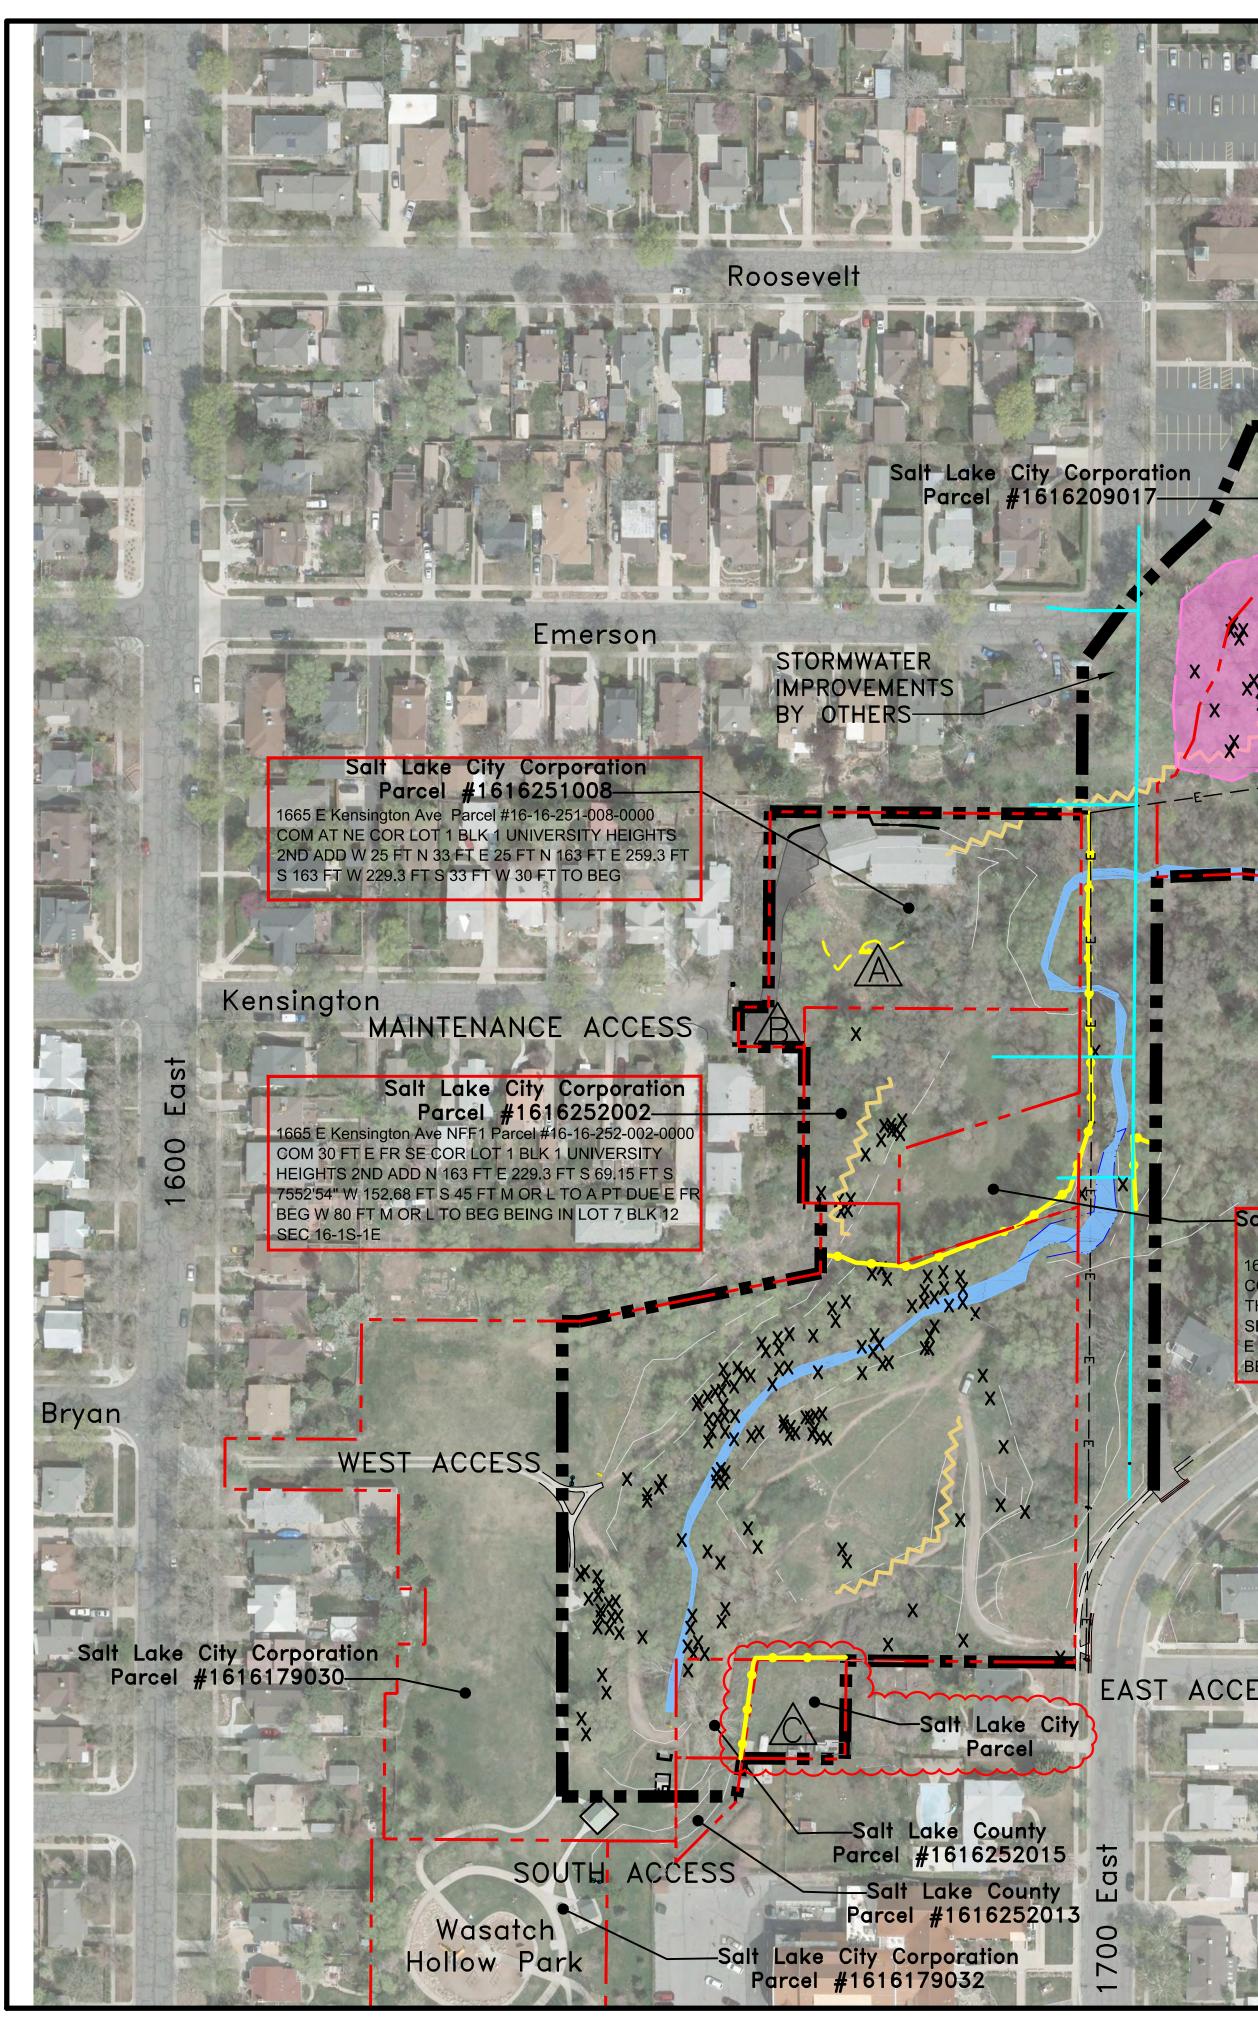
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APPROXIMATE AVERAGE BOTTOM OF CURB BENCHMARK BACK OF CURB BOTTOM OF WALL CALIPER CENTERLINE CUBIC YARD DIAMETER ELEVATION EXISTING FINISH GRADE HORIZONTAL HIGH POINT INCHES LINEAR FEET LOW POINT MAXIMUM MINIMUM MISCELLANEOUS NOT IN CONTRACT NUMBER NOT TO SCALE ON CENTER REQUIRED RIGHT OF WAY SQUARE FOOT SHEET TOP OF CURB TOP OF WALL TYPICAL VERTICAL

# SITE ORIENTATION KEY

1063 West 1400 North Logan, Utah 84321 PREPARER CONSULTANTS: 370 East 500 South, #200 Salt Lake City, Utah 84111 Phone: (801)364-4785 PROFESSIONAL SEAL: PROJECT IDENTIFICATION: WASATCH HOLLOW PRESERVE PHASE II RIPARIAN RESTORATION PROJECT OWNER SALT LAKE CITY CORPORATION ENGINEERING 349 South 200 East, Suite 100 Salt Lake City, Utah 84114–5506 Phone: (801)535–6157 MARK DATE DESCRIPTION PREPARER #: CONTRACT #: PROJECT #: 231504 FILE #: DRAWING FILE DRAWN BY: S. DAVENPORT CHECKED BY: C. SANDS COPYRIGH SHEET TITLE: GENERAL INFORMATION NOTES SHEET IDENTIFIER: **GIO02** 

> BINDING ORDER



Salt Lake City Corporation Parcel #1616252004


1665 E Kensington Ave NFF2 Parcel #16-16-252-004-0000 COM AT A PT S 1358' W 747.61 FT FR MONUMENT AT THE INTERSECTION OF ROOSEVELT AVENUE & SEVENTEENTH EAST STREET S 06' W 95 FT N 7552'5 E 152.68 FT N 06' E 95 FT S 7552'54" W 152.68 FT TO BEG. BEING IN LOT 7, BLK 12, SEC 16, T 1S, R 1E


Bryan

Kensington.


EAST ACCESS

Logan

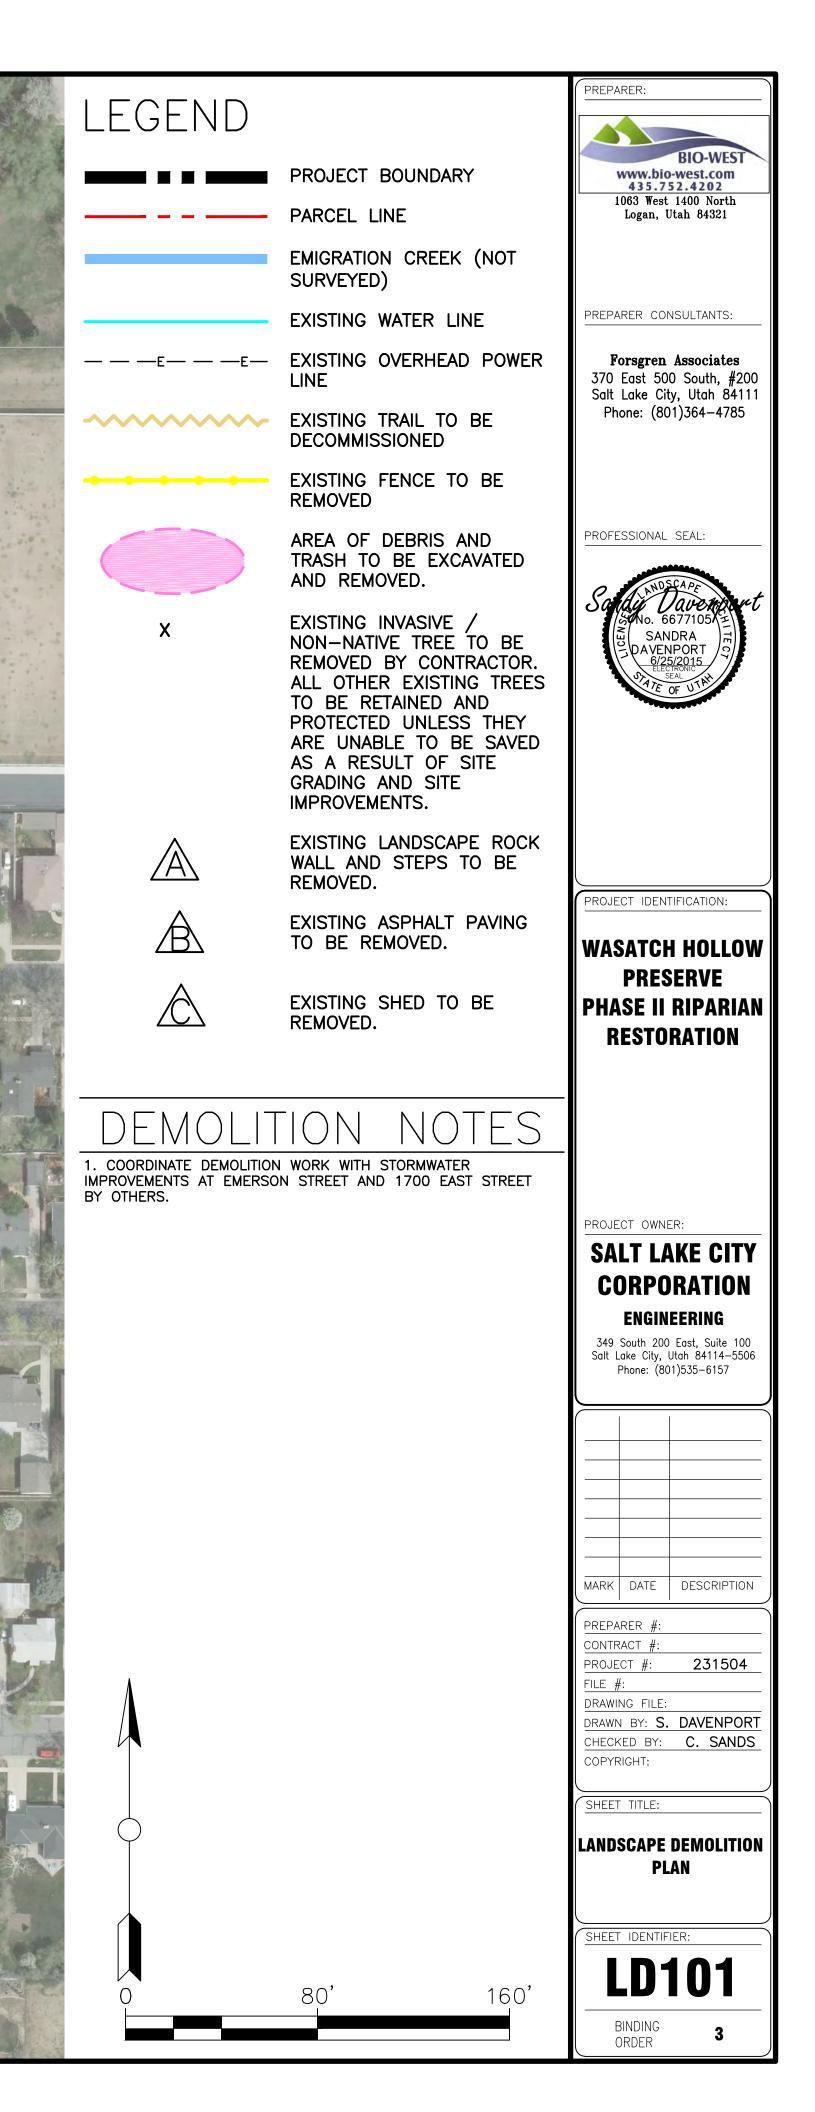


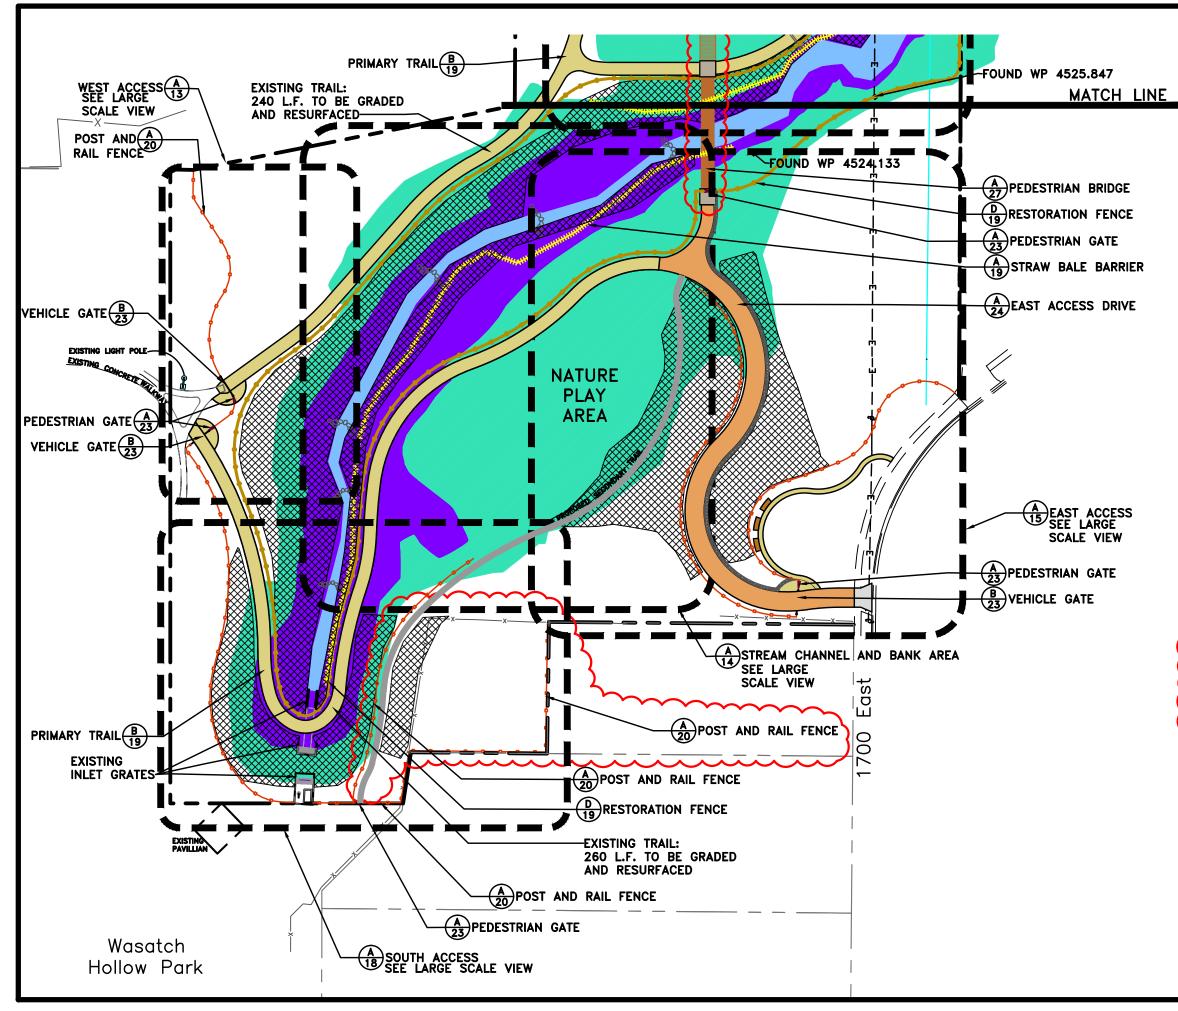


	PREPARER:
LEGEND	BIO-WEST
PROJECT BOUNDARY	www.blo-west.com 435.752.4202 1063 West 1400 North Logan, Utah 84321
EMIGRATION CREEK	• *
CREEK INUNDATION AREA ELEVATION 4521'	PREPARER CONSULTANTS:
CREEK INUNDATION AREA ELEVATION 4529'	Forngren Associates 370 East 500 South, ∯200 Salt Lake City, Utah 84111 Phone: (801)364-4785
EXISTING WATER LINE	
	PROFESSIONAL SEAL:
PROPOSED PEDESTRIAN PRIMARY TRAIL	
PROPOSED PEDESTRIAN SECONDARY TRAIL	
PROPOSED RESTORATION FENCE	
PROPOSED CONCRETE SURFACE	
PROPOSED LIMESTONE CRUSHER FINES SURFACE	PROJECT IDENTIFICATION:
PROPOSED ASPHALT PAVING	PRESERVE Phase II Riparian
PROPOSED EROSION CONTROL BLANKET (SLOPES 3:1 OR >)	RESTORATION
PROPOSED STRAW BALE BARRIER	
PROPOSED ROCK LINED SWALE	
COPOSED ROCK WEIR	PROJECT OWNER:
DETAIL BINDING ORDER SHEET NO.	CORPORATION
	ENGINEERING 349 South 200 East, Suite 100 Satt Lake City, Utah 84114–5506
SITE PLAN NOTES	Satt Lake City, Utah 84114–5506 Phone: (801)535–6157
1. EROSION CONTROL BLANKET TO BE 70% STRAW / 30% COCONUT, WITH TWO-SIDED PHOTODEGRADABLE SYNTHETIC OR	
ORGANIC NETS AND A MINIMUM BLANKET WEIGHT OF 0.5 LBS. / SQ. YD. INSTALL STRICTLY FOLLOWING MANUFACTURE'S	
SPECIFICATIONS AND SECTION 31 25 00 INCLUDING PLACEMENT, OVERLAP, STAPLE ANCHORS, AND EMBEDDING, MINIMIZE DISTURBANCE OF THE PREPARED SEEDBED.	
	MARK DATE DESCRIPTION
	PREPARER #: CONTRACT #:
٨	PROJECT #: 231504 FILE #:
	DRAWING FILE: DRAWN BY: S. DAVENPORT
	CHECKED BY: C. SANDS COPYRIGHT:
	SHEET TITLE:
	LANDSCAPE SITE PLAN
	SHEET IDENTIFIER:
0 30' 60' 120'	LS101
	BINDING <b>4</b> ORDER <b>4</b>

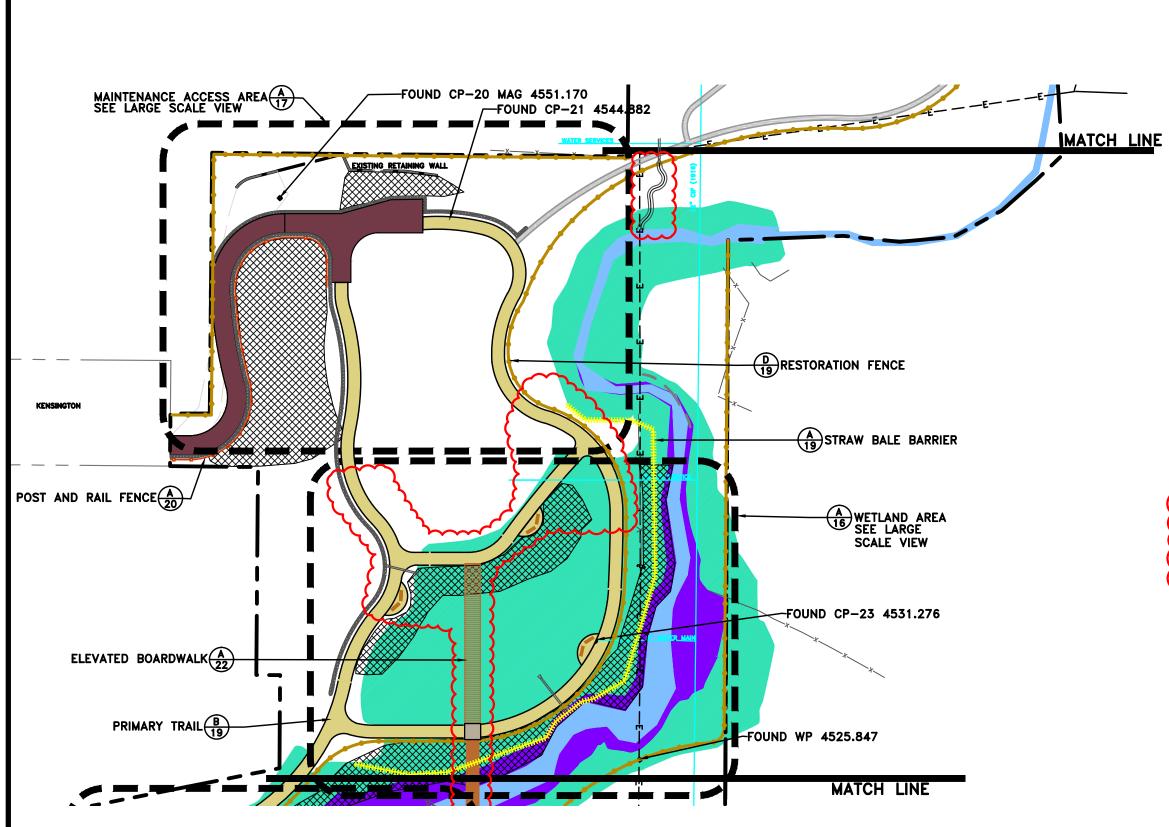


	PREPARER:
LEGEND	BIO-WEST
PROJECT BOUNDARY	www.blo-west.com 435.752.4202 1063 West 1400 North Logan, Utah 84321
EMIGRATION CREEK	
CREEK INUNDATION AREA ELEVATION 4521'	PREPARER CONSULTANTS:
CREEK INUNDATION AREA ELEVATION 4529'	Foragren Associates 370 East 500 South, #200 Salt Lake City, Utah 84111 Phone: (801)364-4785
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	PROFESSIONAL SEAL:
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PROPOSED PEDESTRIAN SECONDARY TRAIL	
PROPOSED RESTORATION FENCE	
PROPOSED CONCRETE SURFACE	
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+	
PROPOSED ROCK LINED SWALE	
Correction of the second secon	PROJECT OWNER:
DETAIL BINDING ORDER SHEET NO.	CORPORATION
~~~~~~~~~~~~~~~~~~~~~~~~~~~~~~~~~~~~~~~	ENGINEERING 349 South 200 East, Suite 100 Salt Lake City, Utah 84114–5506
SITE PLAN NOTES	Phone: (801)535–6157
1. EROSION CONTROL BLANKET TO BE 70% STRAW / 30% COCONUT, WITH TWO-SIDED PHOTODEGRADABLE SYNTHETIC OR ORGANIC NETS AND A MINIMUM BLANKET WEIGHT OF 0.5 LBS. / SQ. YD. INSTALL STRICTLY FOLLOWING MANUFACTURE'S SPECIFICATIONS AND SECTION 31 25 00 INCLUDING PLACEMENT, OVERLAP, STAPLE ANCHORS, AND EMBEDDING. MINIMIZE DISTURBANCE OF THE PREPARED SEEDBED.	
	MARK DATE DESCRIPTION
	PREPARER #: CONTRACT #:
٨	PROJECT #: 231504 FILE #: DRAWING FILE:
	DRAWING FILE: DRAWN BY: S. DAVENPORT CHECKED BY: C. SANDS COPYRIGHT:
	SHEET TITLE:
	LANDSCAPE SITE PLAN
	SHEET IDENTIFIER:
0 30' 60' 120'	<b>LS102</b>
	Binding 5 Order 5

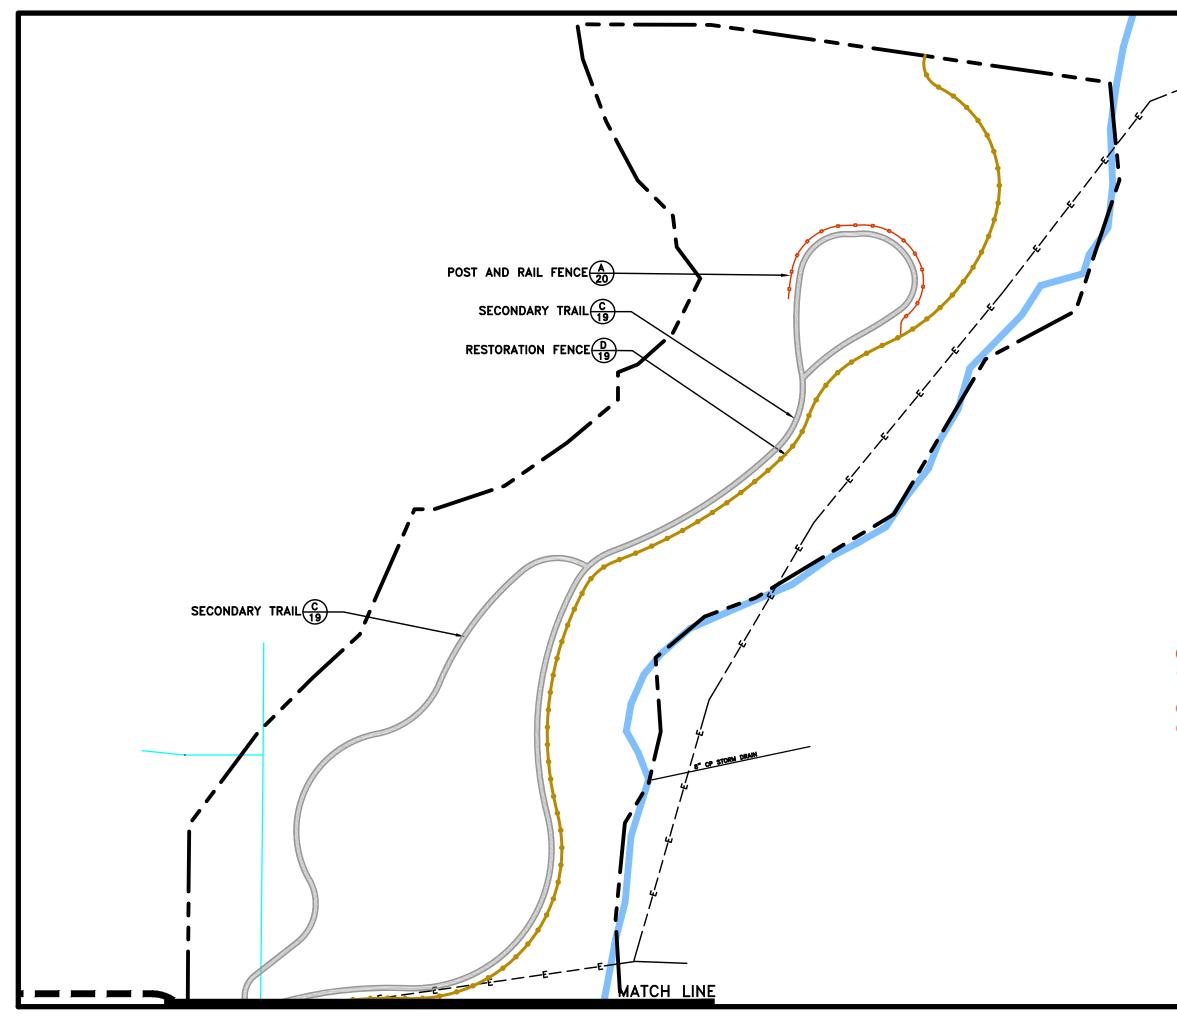


	PREPARER:
LEGEND	BIO-WEST
PROJECT BOUNDARY	www.bio-west.com 435.752.4202 1063 West 1400 North Logan, Utah 84321
EMIGRATION CREEK	
CREEK INUNDATION AREA ELEVATION 4521'	PREPARER CONSULTANTS:
CREEK INUNDATION AREA ELEVATION 4529'	Forsgren Associates 370 East 500 South, #200 Salt Lake City, Utah 84111 Phone: (801)364-4785
EXISTING WATER LINE	
	PROFESSIONAL SEAL:
PROPOSED PEDESTRIAN PRIMARY TRAIL	
PROPOSED PEDESTRIAN SECONDARY TRAIL	
PROPOSED RESTORATION FENCE	
PROPOSED CONCRETE SURFACE	
PROPOSED LIMESTONE CRUSHER FINES SURFACE	PROJECT IDENTIFICATION:
PROPOSED ASPHALT PAVING	PRESERVE PHASE II RIPARIAN
PROPOSED EROSION CONTROL BLANKET (SLOPES 3:1 OR >)	RESTORATION
PROPOSED STRAW BALE BARRIER	
PROPOSED ROCK LINED SWALE	
PROPOSED ROCK WEIR	PROJECT OWNER:
DETAIL BINDING ORDER SHEET NO.	CORPORATION
	ENGINEERING 349 South 200 East, Suite 100 Salt Lake City, Utah 84114–5506
SITE PLAN NOTES	Phone: (801)535-6157
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SECTIONE AND SECTION 31 25 00 INCLUDING PLACEMENT, OVERLAP, STAPLE ANCHORS, AND EMBEDDING. MINIMIZE DISTURBANCE OF THE PREPARED SEEDBED.	
	MARK DATE DESCRIPTION
	CONTRACT #: PROJECT #: 231504
	FILE #: DRAWING FILE: DRAWN BY: <b>S. DAVENPORT</b>
	CHECKED BY: C. SANDS COPYRIGHT:
	SHEET TITLE:
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	SHEET IDENTIFIER:
0 30' 60' 120'	LS103
	BINDING 6 ORDER 6

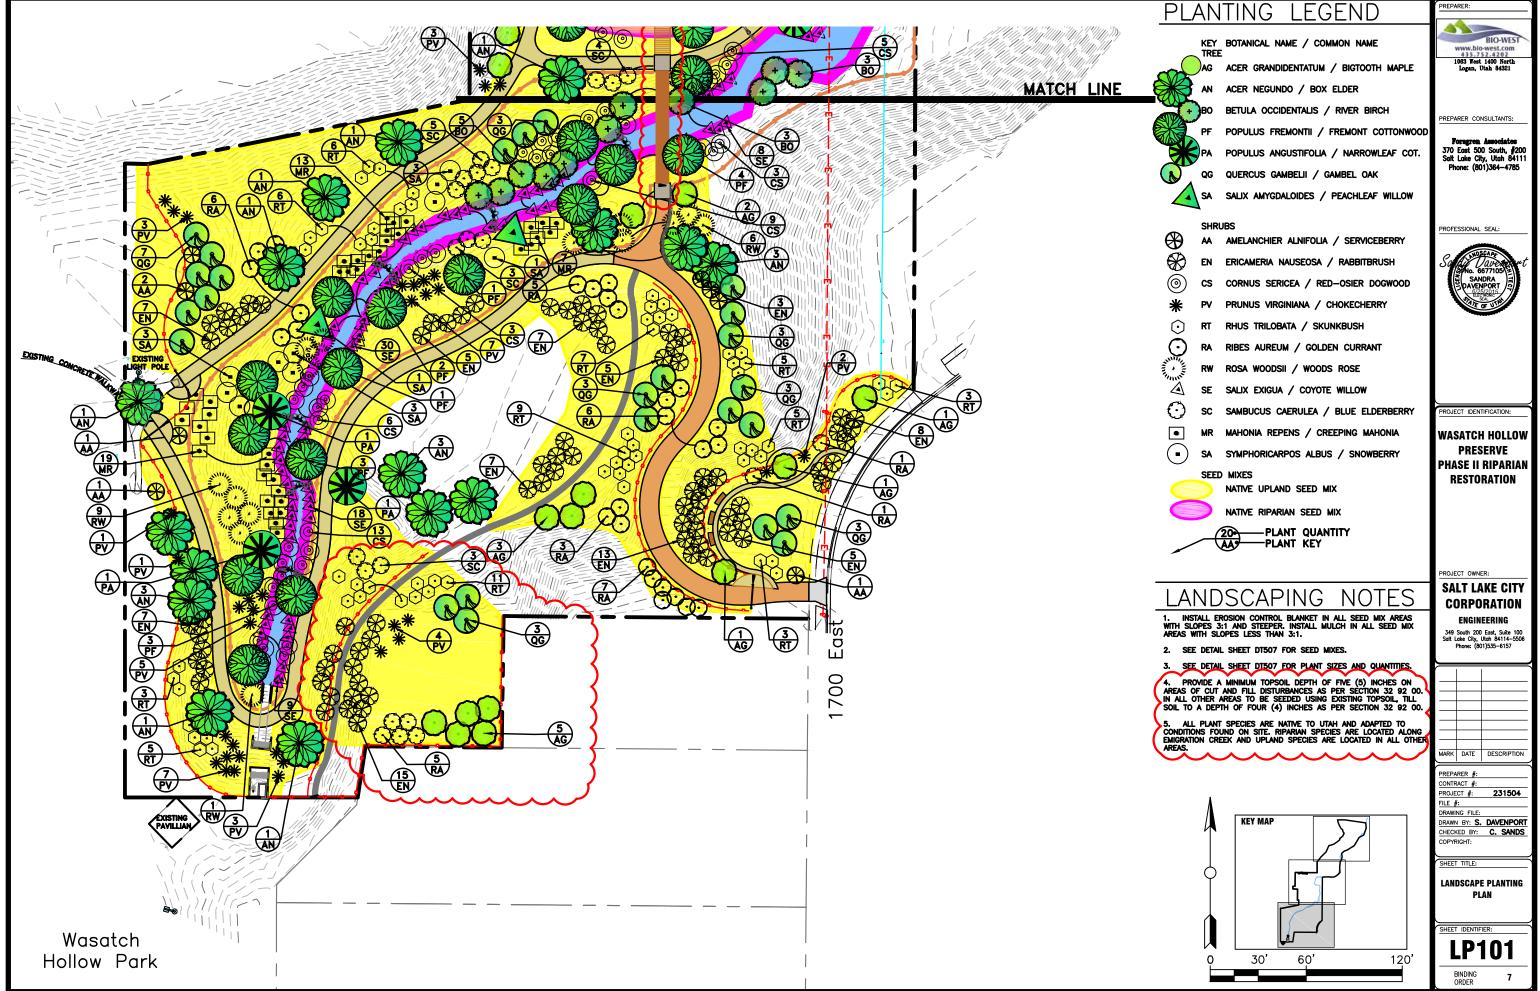


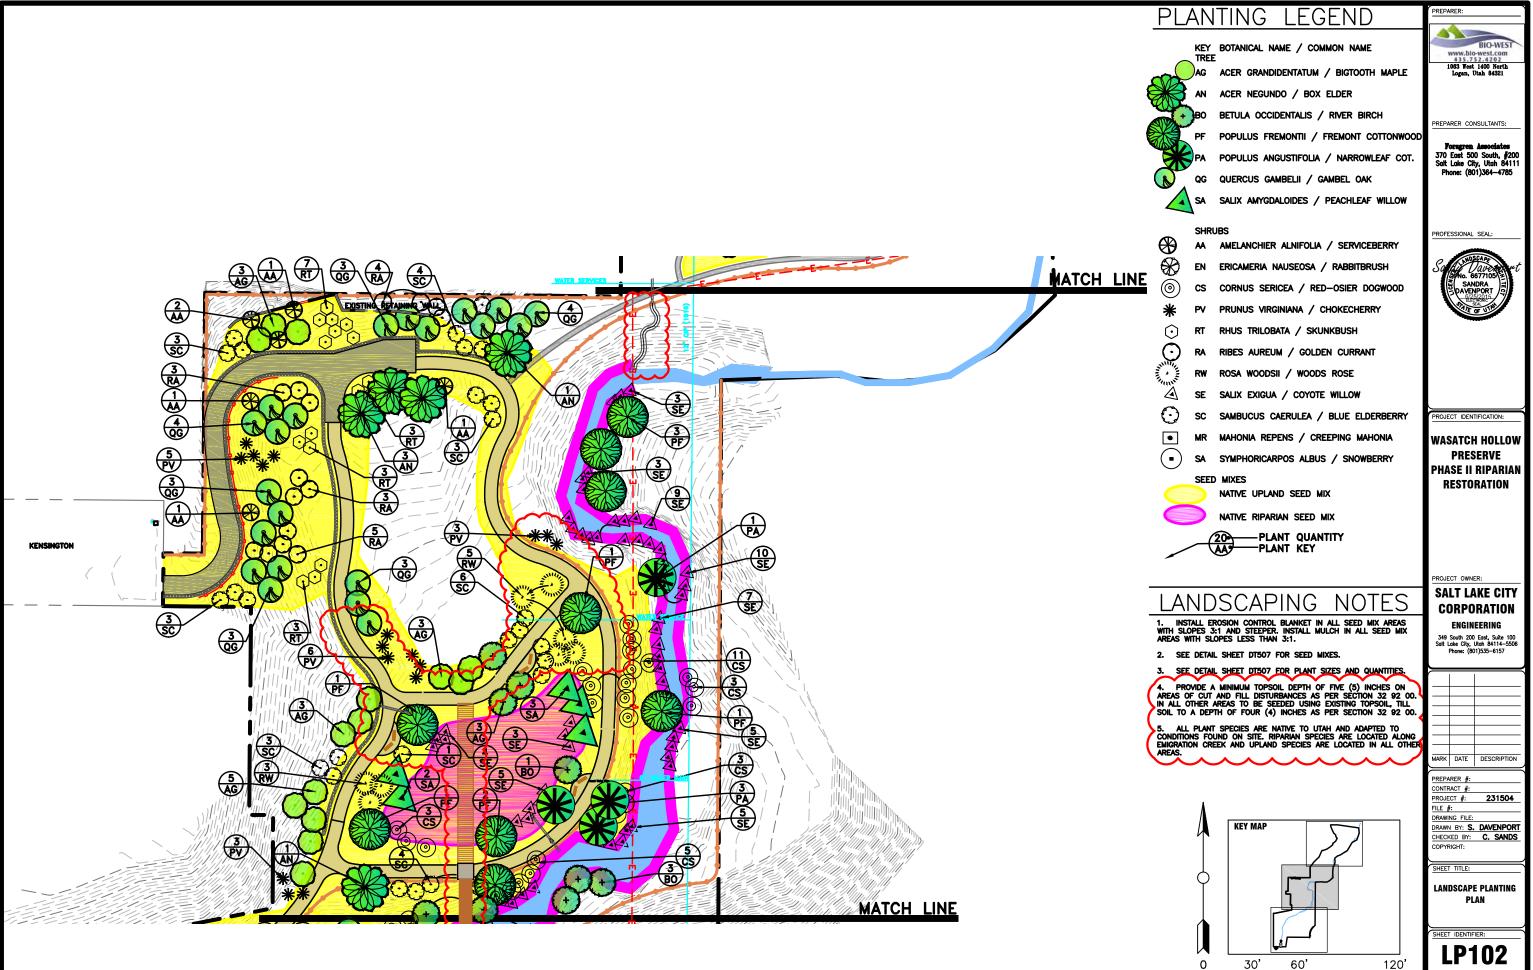



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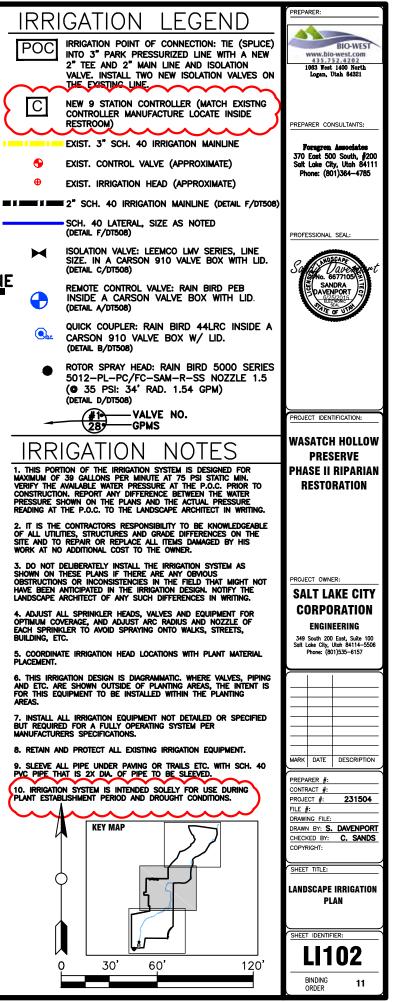
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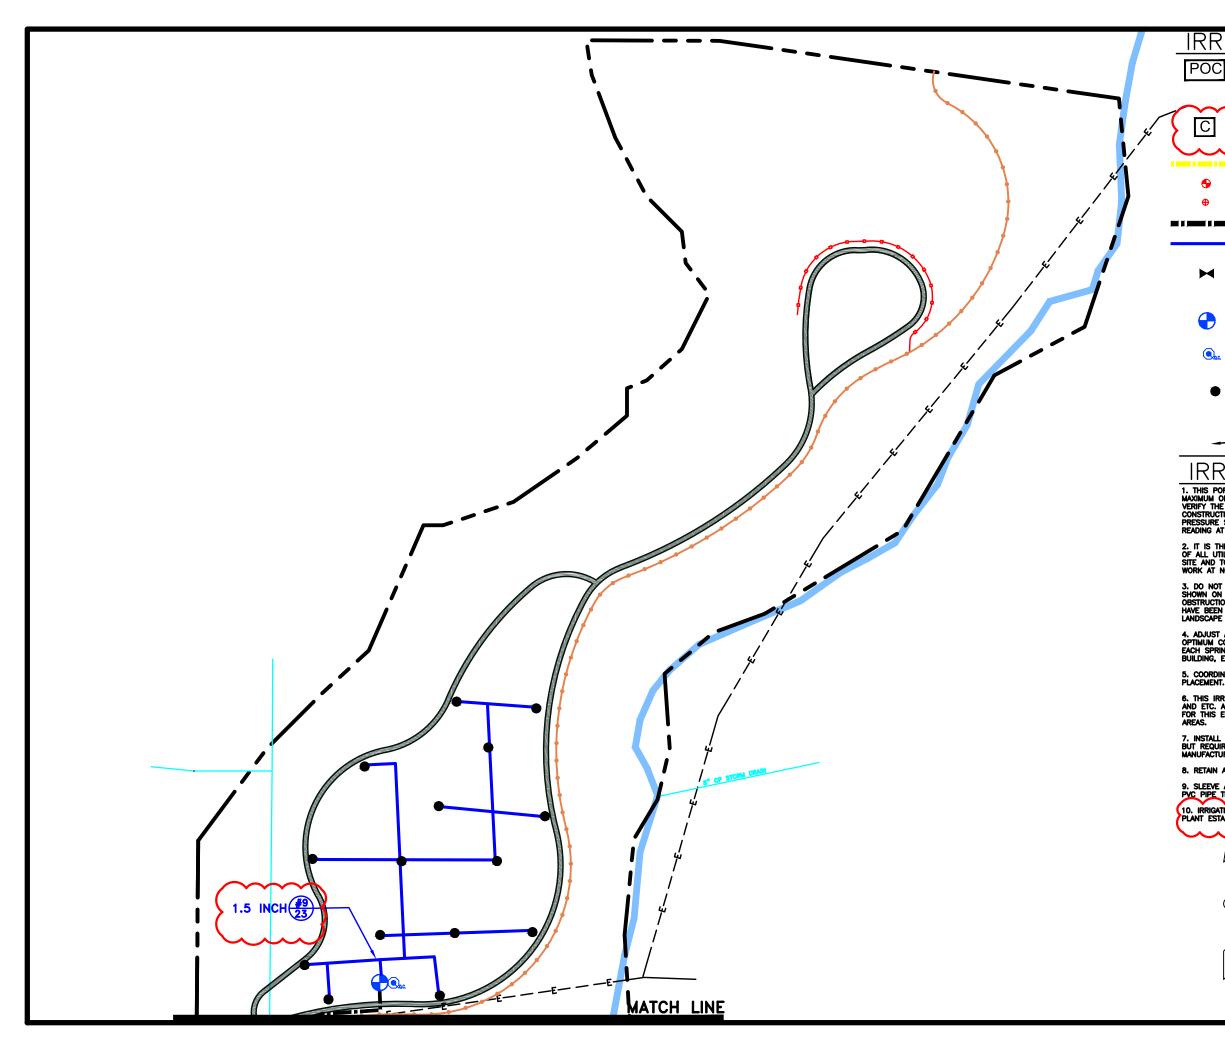





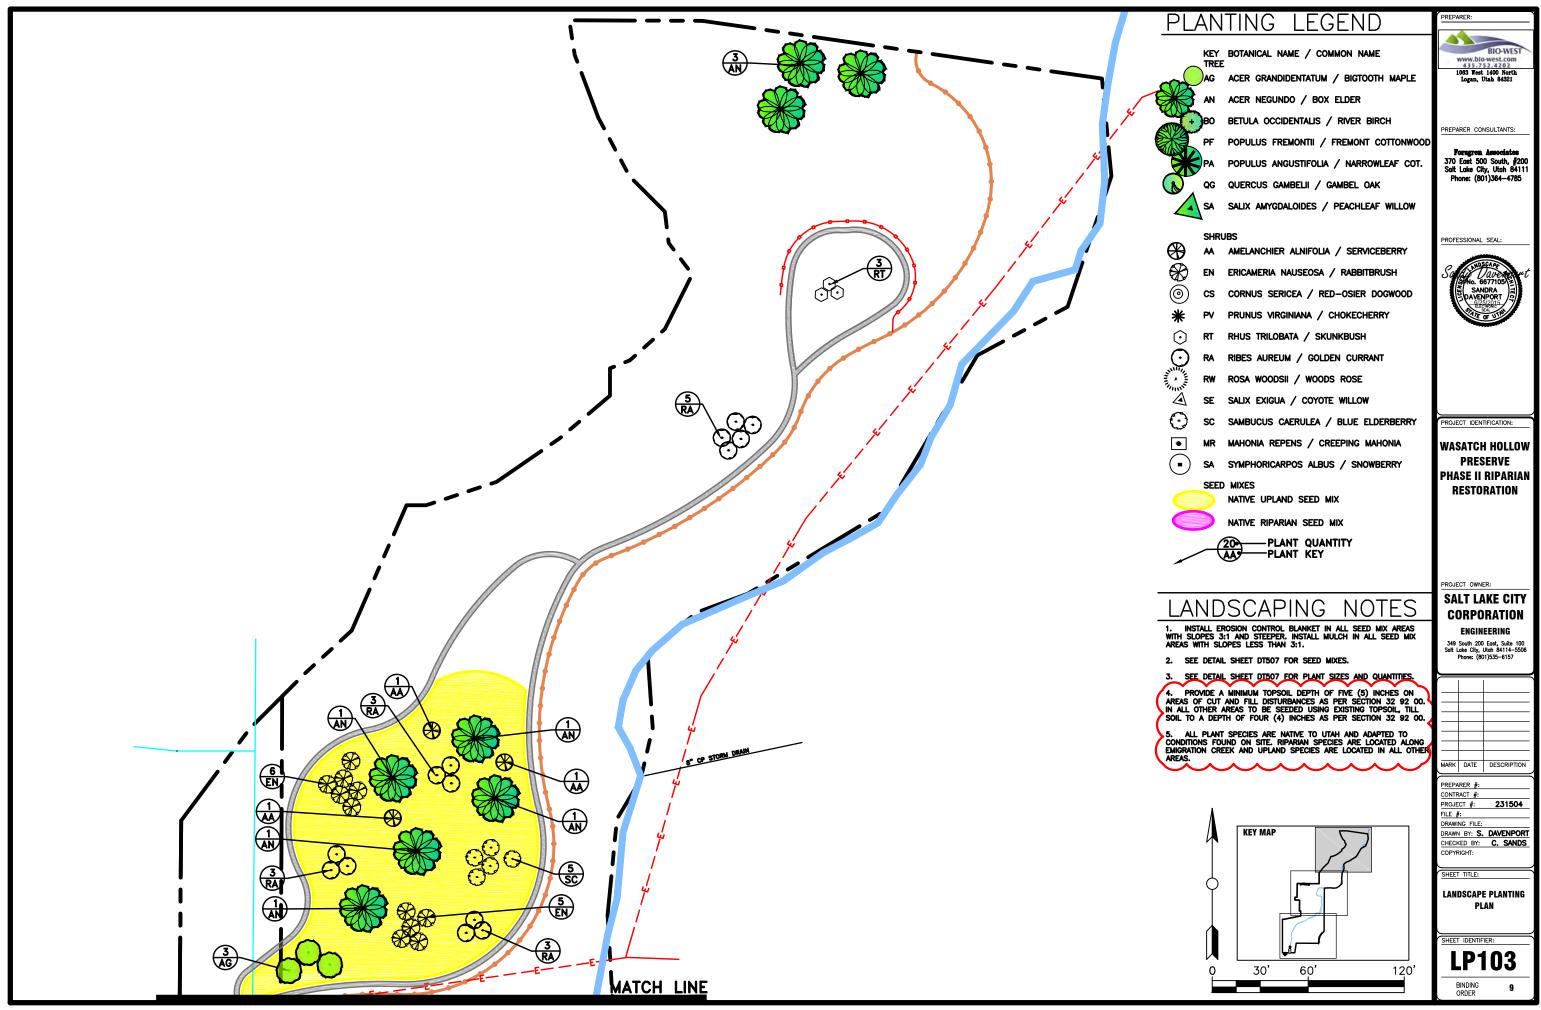

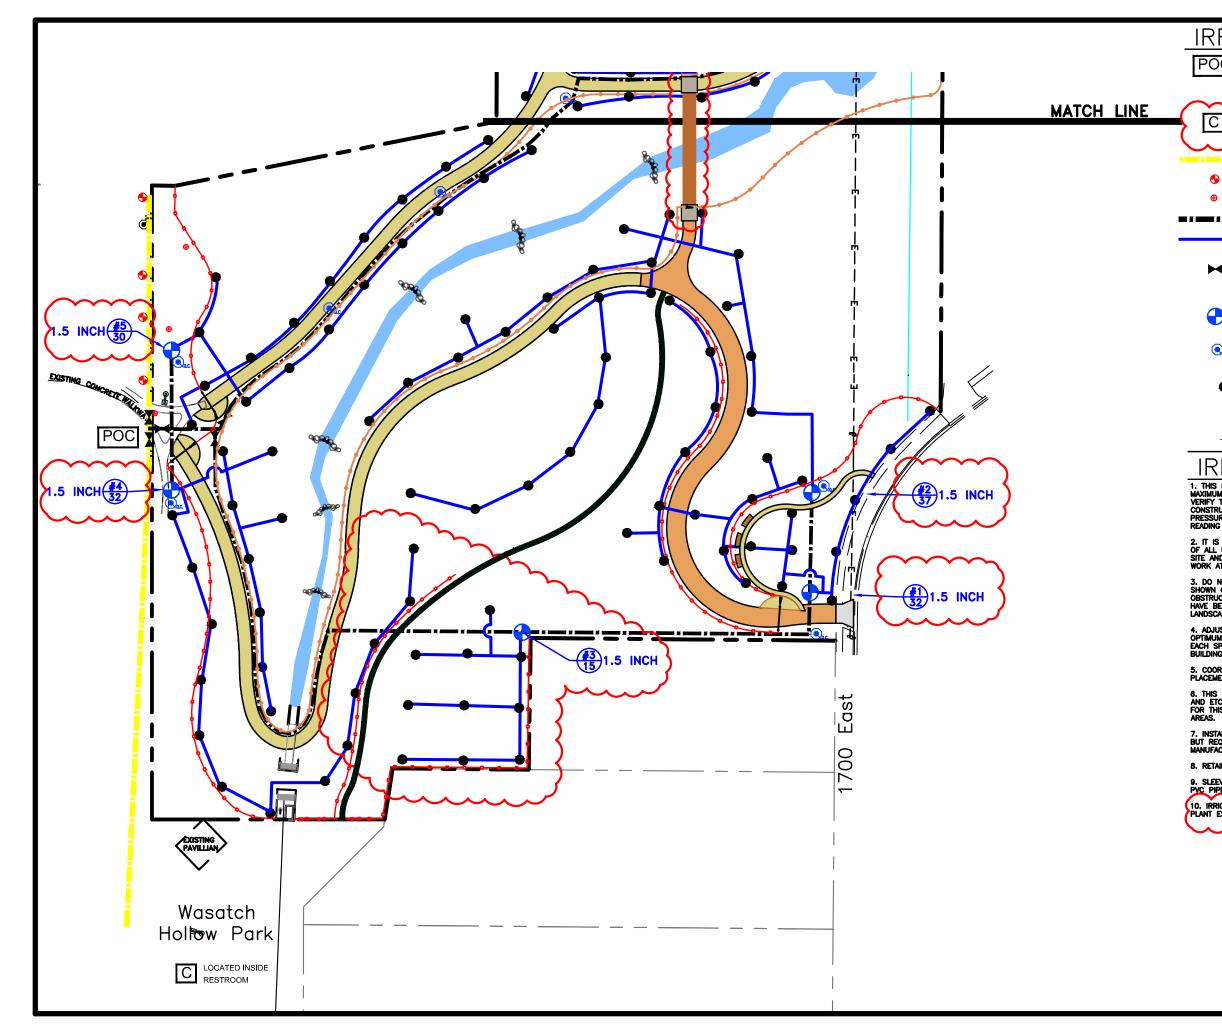


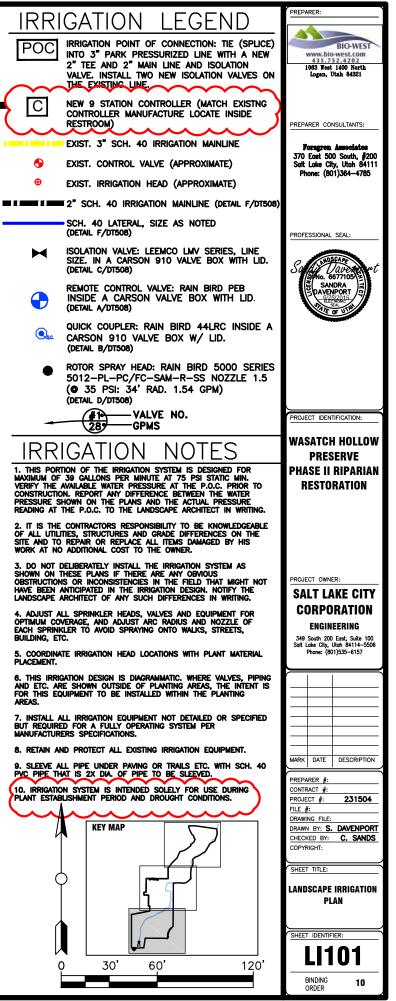


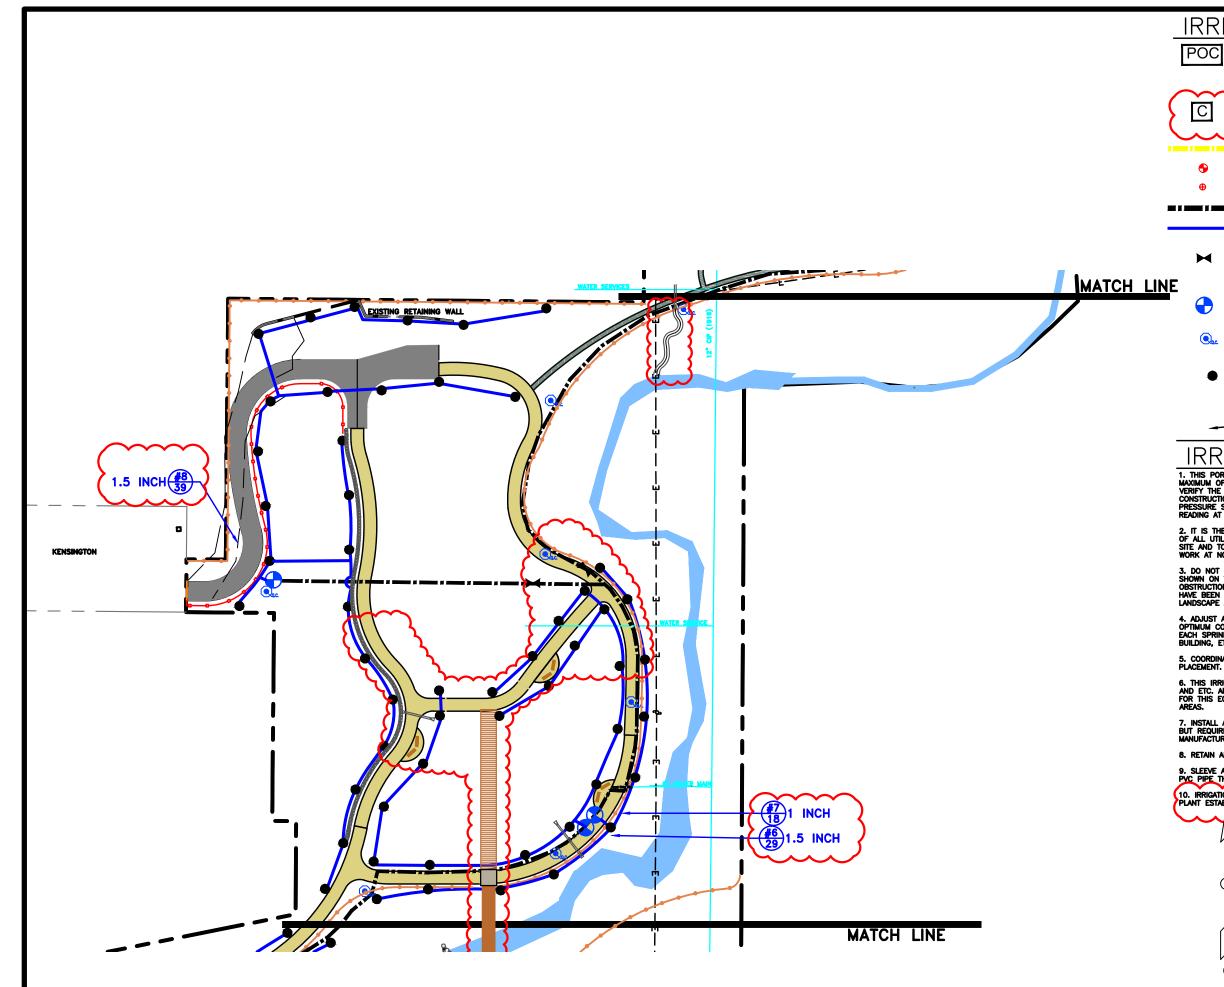

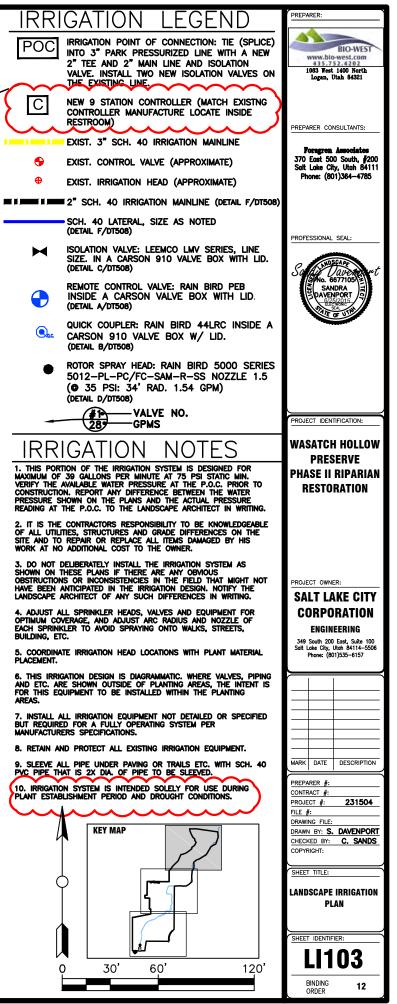


LEGEND

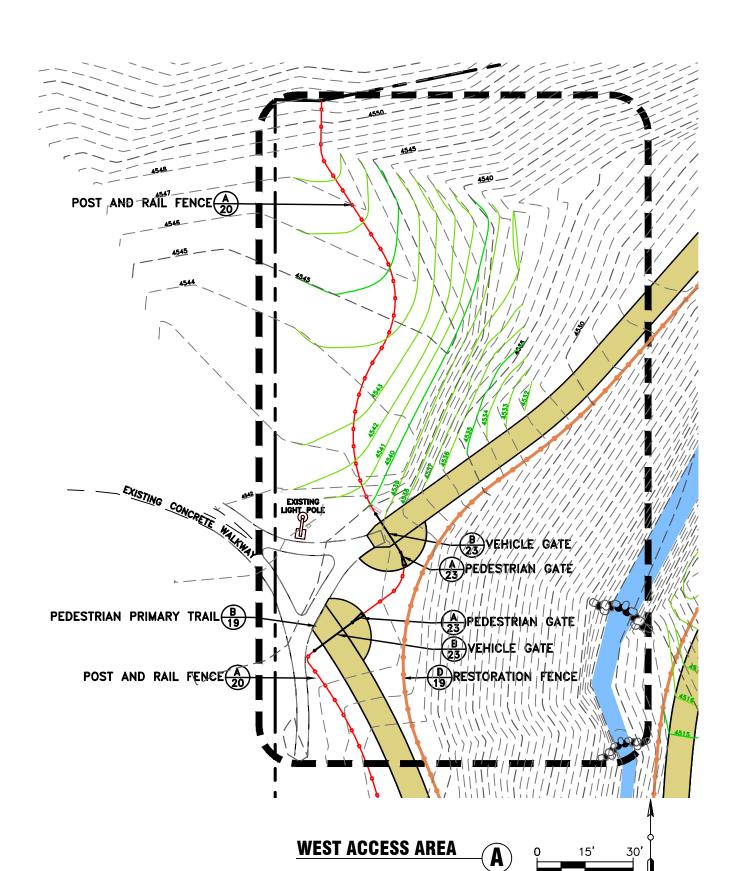


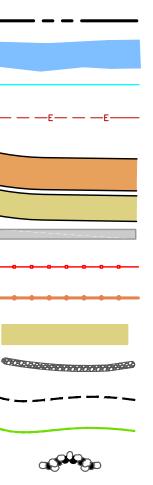

PROJECT BOUNDARY EMIGRATION CREEK EXISTING WATER LINE EXISTING OVERHEAD POWER LINE EXISTING FENCE EAST ACCESS DRIVE PROPOSED PRIMARY TRAIL PROPOSED SECONDARY TRAIL PROPOSED POST & RAIL FENCE PROPOSED RESTORATION FENCE PROPOSED LIMESTONE CRUSHER FINES SURFACE PROPOSED ROCK LINED SWALE EXISTING CONTOUR PROPOSED CONTOUR PROPOSED ROCK WEIR



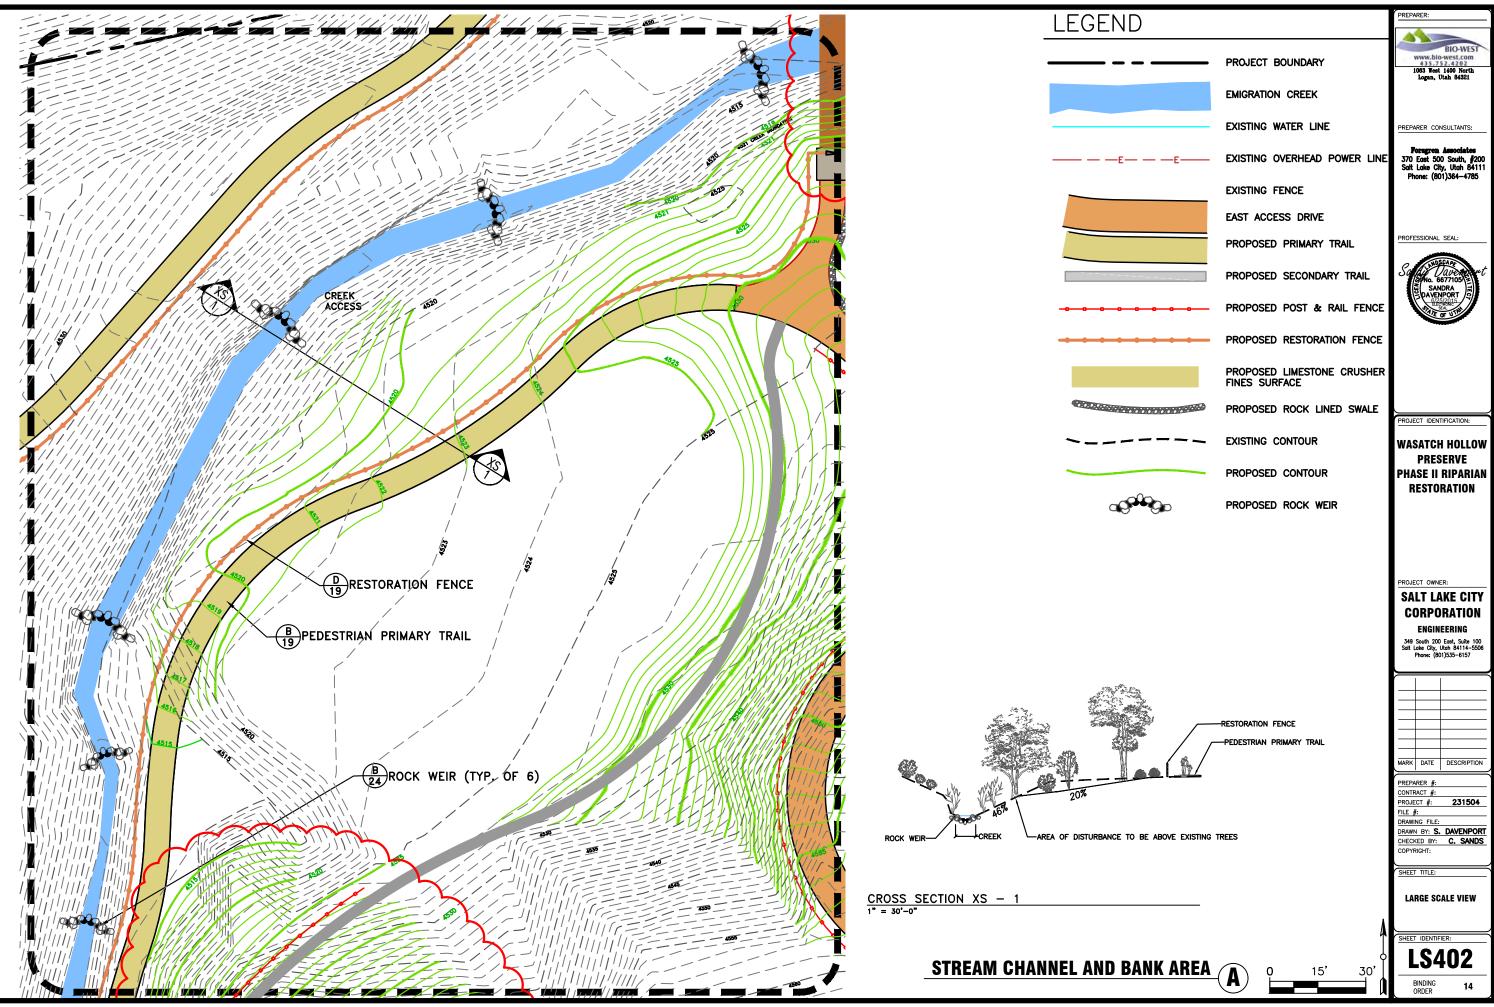

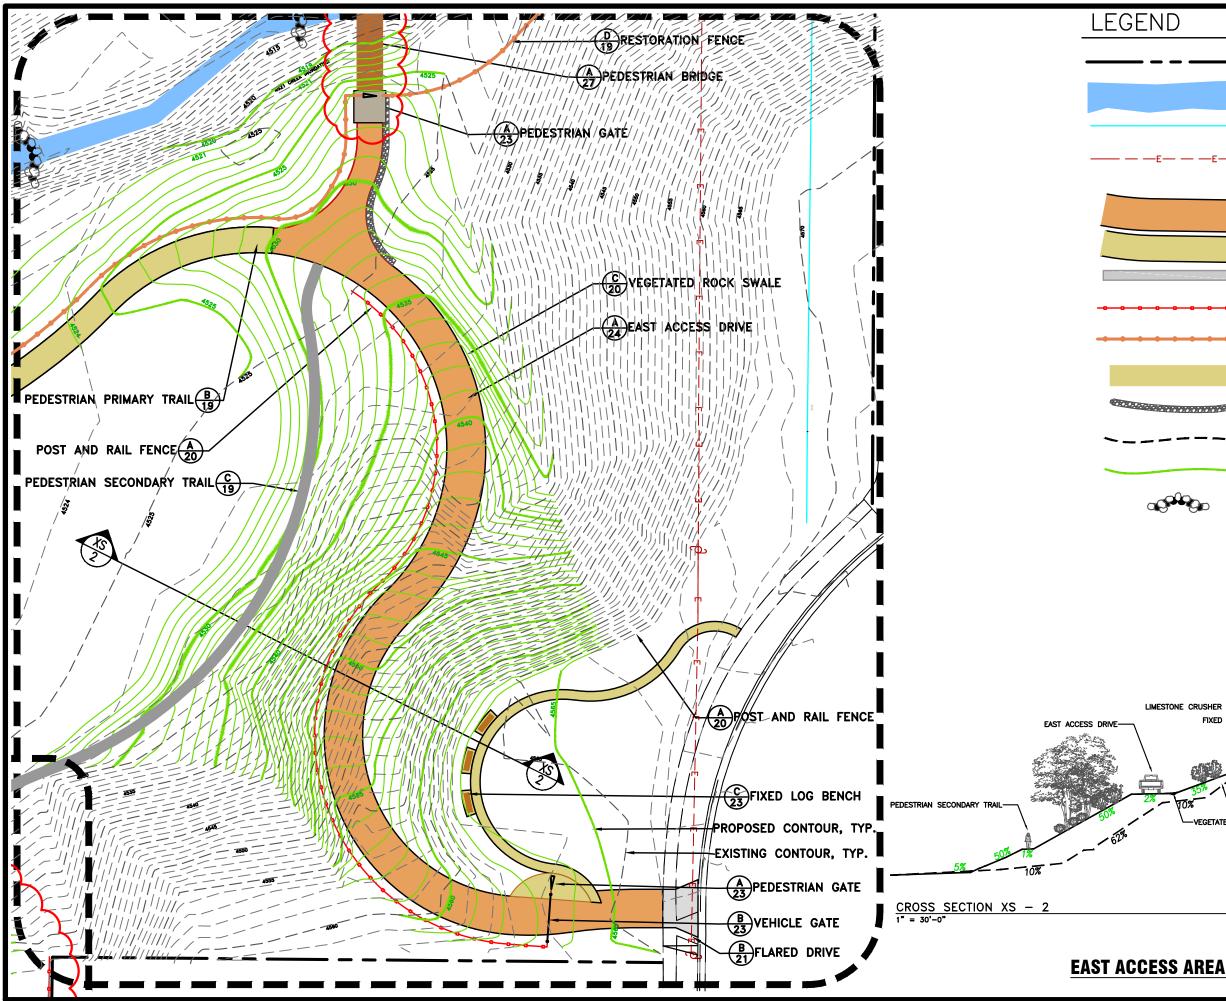

## PARER: BIO-WES www.bio-west.com 435.752.4202 1063 West 1400 North PROJECT BOUNDARY Logan, Utah 8432 EMIGRATION CREEK EXISTING WATER LINE REPARER CONSULTANTS: Forsgren Associates 370 East 500 South, #200 Salt Lake City, Utah 84111 Phone: (801)364-4785 EXISTING OVERHEAD POWER LINE -F---EXISTING FENCE EAST ACCESS DRIVE ROFESSIONAL SEA PROPOSED PRIMARY TRAIL PROPOSED SECONDARY TRAIL PROPOSED POST & RAIL FENCE PROPOSED RESTORATION FENCE PROPOSED LIMESTONE CRUSHER FINES SURFACE PROPOSED ROCK LINED SWALE ROJECT IDENTIFICATION: EXISTING CONTOUR WASATCH HOLLOW PRESERVE PROPOSED CONTOUR PHASE II RIPARIAN RESTORATION a children PROPOSED ROCK WEIR ROJECT OWNER: SALT LAKE CITY CORPORATION ENGINEERING 349 South 200 East, Suite 100 Salt Lake City, Utah 84114-5508 Phone: (801)535-6157 LIMESTONE CRUSHER FINES SURFACE-FIXED LOG BENCH ARK DATE DESCRIPTION PREPARER #: CONTRACT #: OPOSED GRADE 231504 PROJECT #: -EXISTING GRADE FILE #: VEGETATED ROCK SWALE DRAWING FILE DRAWN BY: S. DAVENPORT CHECKED BY: C. SANDS OPYRIGHT SHEET TITLE: LARGE SCALE VIEW

EET IDENTIFIER

BINDING ORDER


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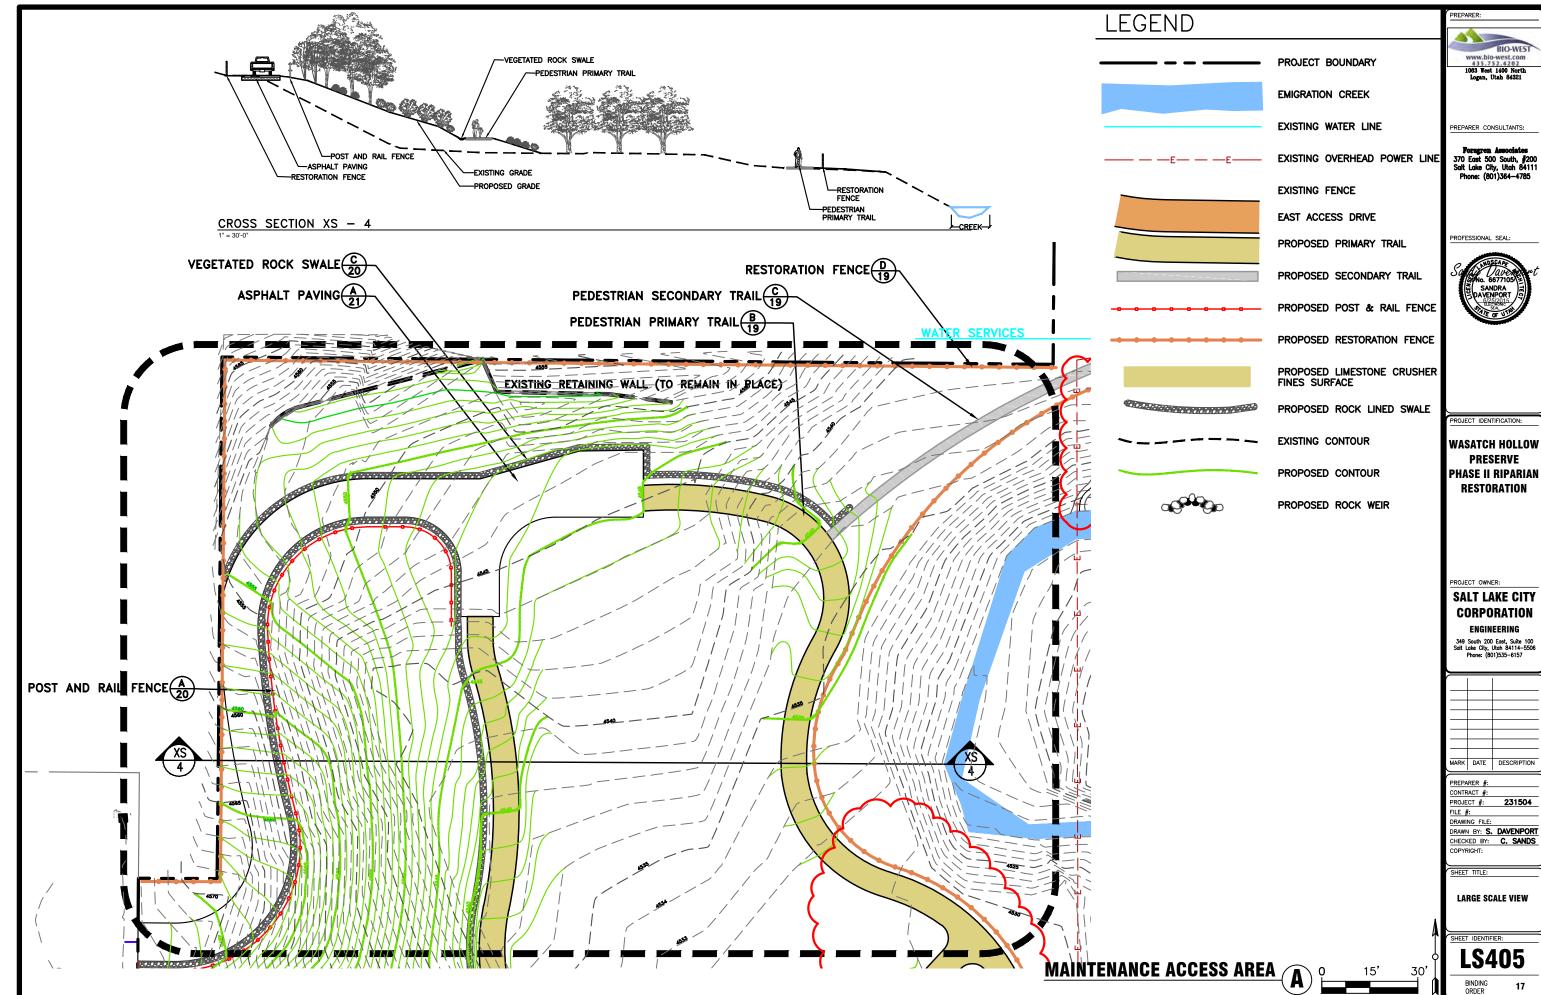
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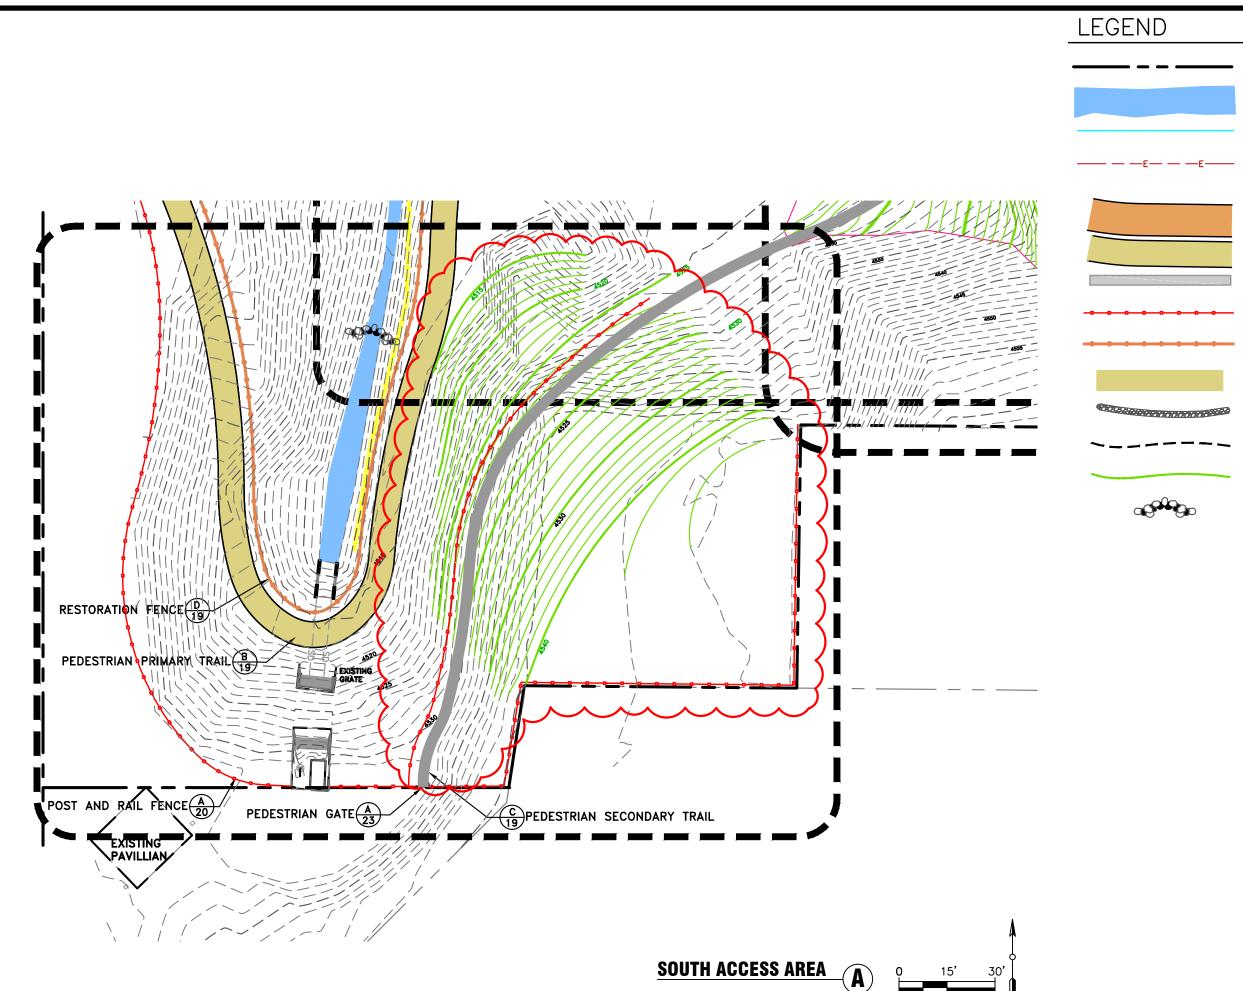
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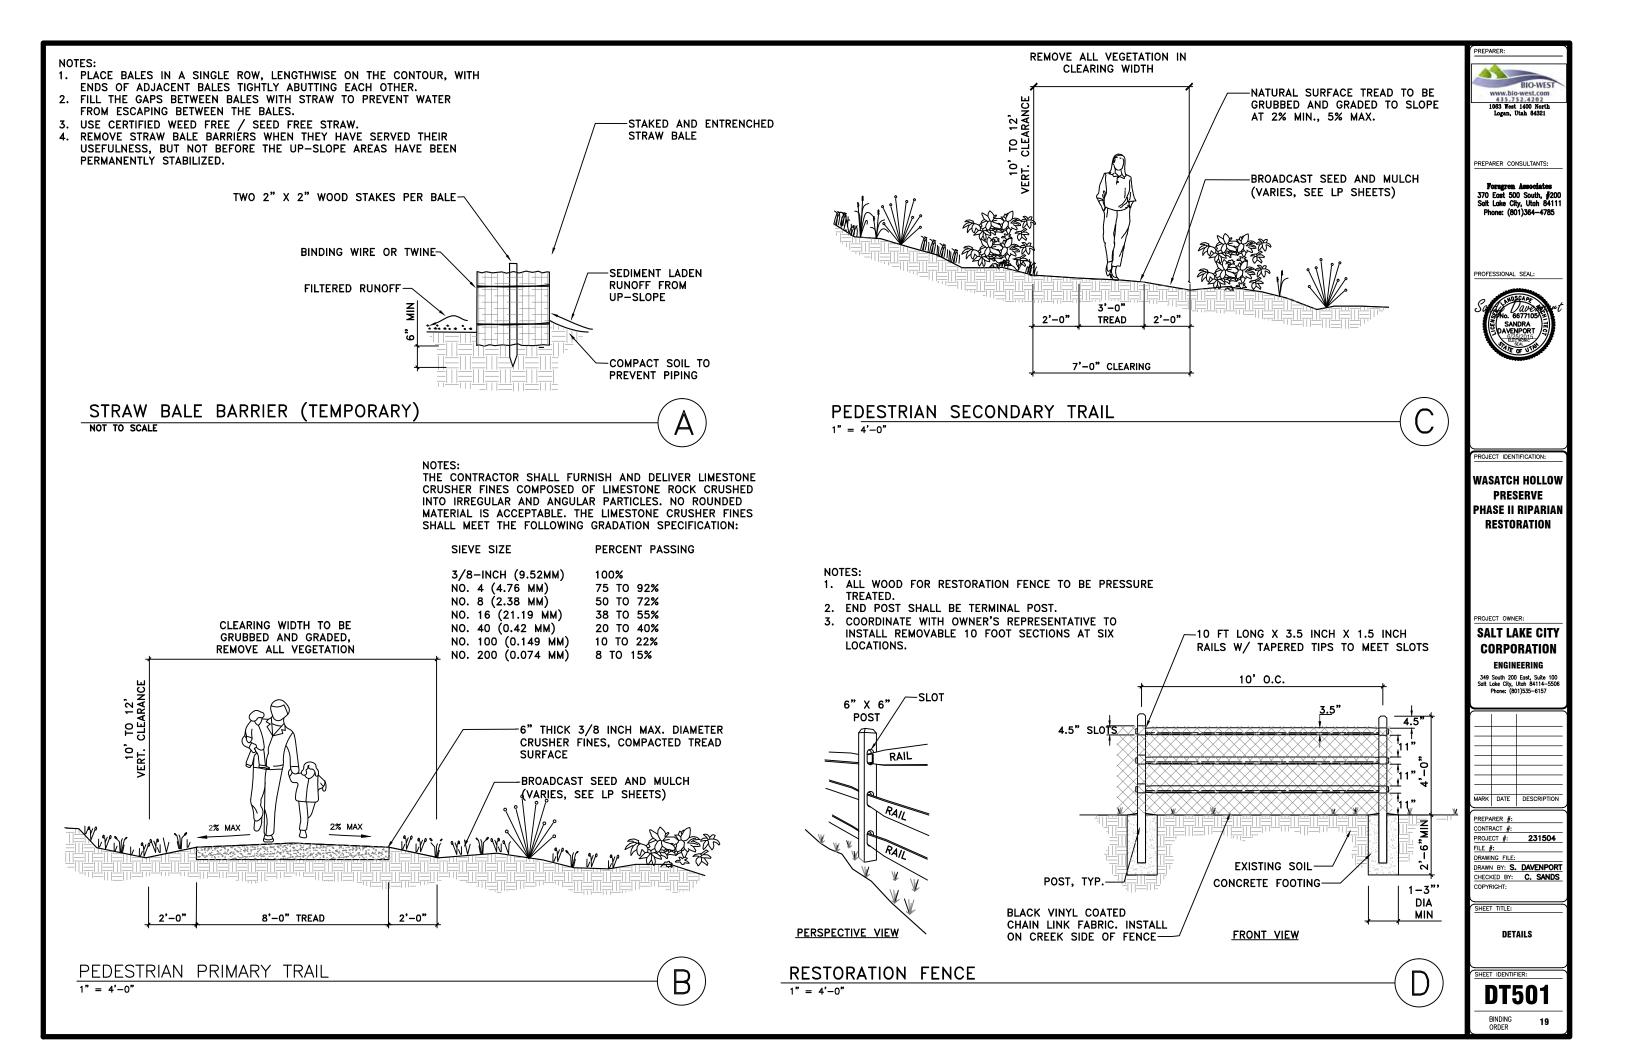
FND		PREPARER:
LIND		
	PROJECT BOUNDARY	BIO-WEST www.bio-west.com 435.752.4202 1063 West 1400 North Logan, Utah 84321
	EMIGRATION CREEK	
	EXISTING WATER LINE	PREPARER CONSULTANTS:
—E— — —E——	EXISTING OVERHEAD POWER LINE	Foregren Associates 370 East 500 South, ∯200 Salt Lake City, Utah 84111 Phone: (801)364-4785
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	EAST ACCESS DRIVE	
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	PROPOSED SECONDARY TRAIL	Sally Daverguet
<b></b> 00	PROPOSED POST & RAIL FENCE	PANENPORT
·····	PROPOSED RESTORATION FENCE	
	PROPOSED LIMESTONE CRUSHER FINES SURFACE	
	PROPOSED ROCK LINED SWALE	PROJECT IDENTIFICATION:
	EXISTING CONTOUR	WASATCH HOLLOW PRESERVE
	PROPOSED CONTOUR	PHASE II RIPARIAN RESTORATION
	PROPOSED ROCK WEIR	
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TERIAL AND IS LIKELY TO CONTA REMOVED AND DISPOSED OF O	NN CONSTRUCTION WASTE THAT WILL FF-SITE.	SALT LAKE CITY
stories suggest a natural si intent of this area is to un the wetland.	PRING ONCE EXISTED AT THIS LOCATION. IEARTH THE NATURAL SPRING AND USE IT	CORPORATION ENGINEERING
GRADING AS NECESSARY WHEN	ORIGINAL TOPOGRAPHY IS ENCOUNTERED BLE FILL IS ENCOUNTERED (E.G. MORE	349 South 200 East, Suite 100 Salt Lake City, Utah 84114-5506 Phone: (801)535-6157
		MARK   DATE   DESCRIPTION
		CONTRACT #: PROJECT #: 231504
		FILE #: DRAWING FILE: DRAWN BY: <b>S. DAVENPORT</b> CHECKED BY: <b>C. SANDS</b> COPYRIGHT:
		LARGE SCALE VIEW
	A	SHEET IDENTIFIER:
D AREA	<b>0</b> 15' 30'	LS404
(		BINDING 16 ORDER 16





PROJECT BOUNDARY EMIGRATION CREEK EXISTING WATER LINE EXISTING OVERHEAD POWER LINE EXISTING FENCE EAST ACCESS DRIVE PROPOSED PRIMARY TRAIL PROPOSED SECONDARY TRAIL PROPOSED POST & RAIL FENCE PROPOSED RESTORATION FENCE PROPOSED LIMESTONE CRUSHER FINES SURFACE PROPOSED ROCK LINED SWALE EXISTING CONTOUR PROPOSED CONTOUR PROPOSED ROCK WEIR



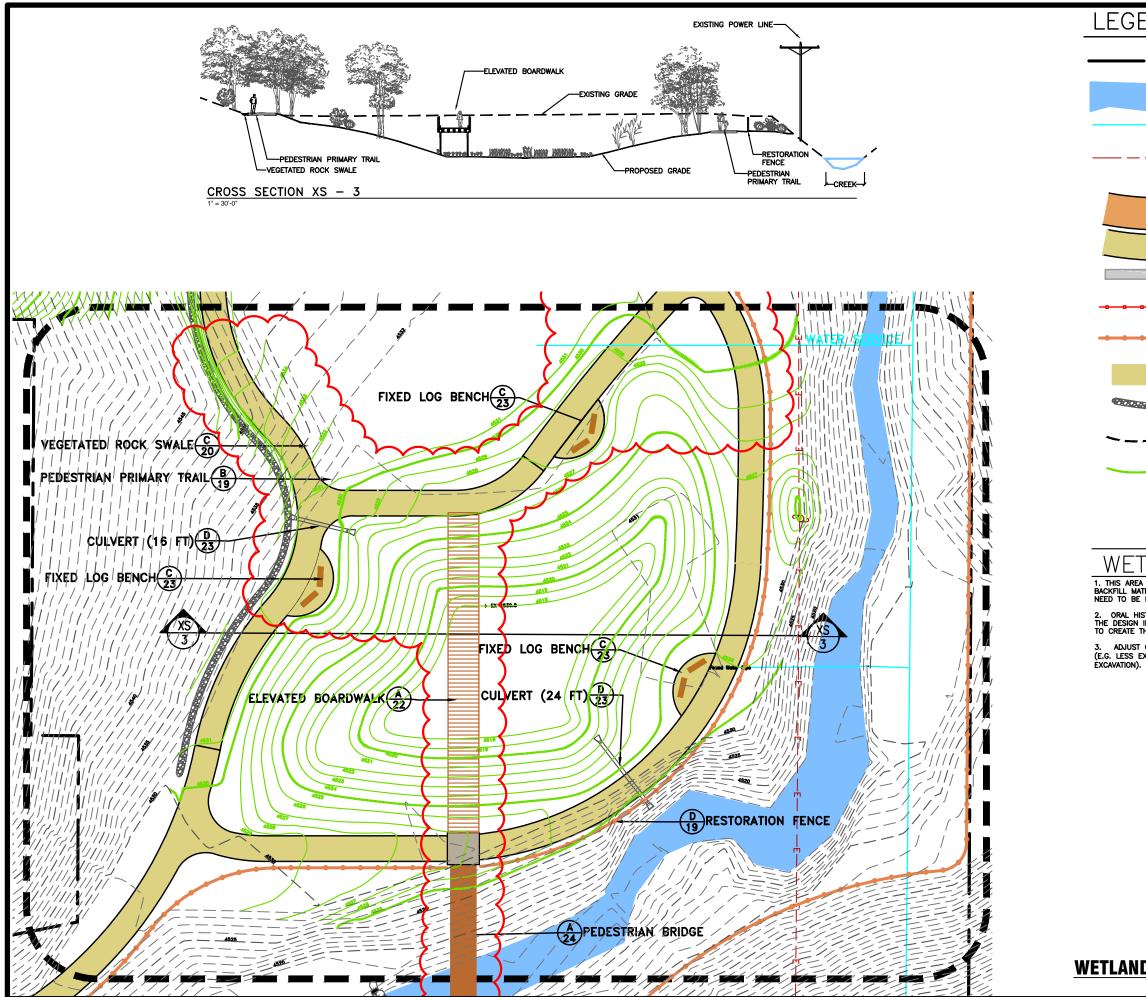



- 1. ALL WOOD FOR POST AND RAIL FENCE TO BE PRESSURE TREATED.
- 2. PRE-DRILL HOLES TO PREVENT SPLITTING DURING CONSTRUCTION.

3' MIN FROM EDGE

OF TRAIL;

5' MIN FROM EDGE

OF ROAD

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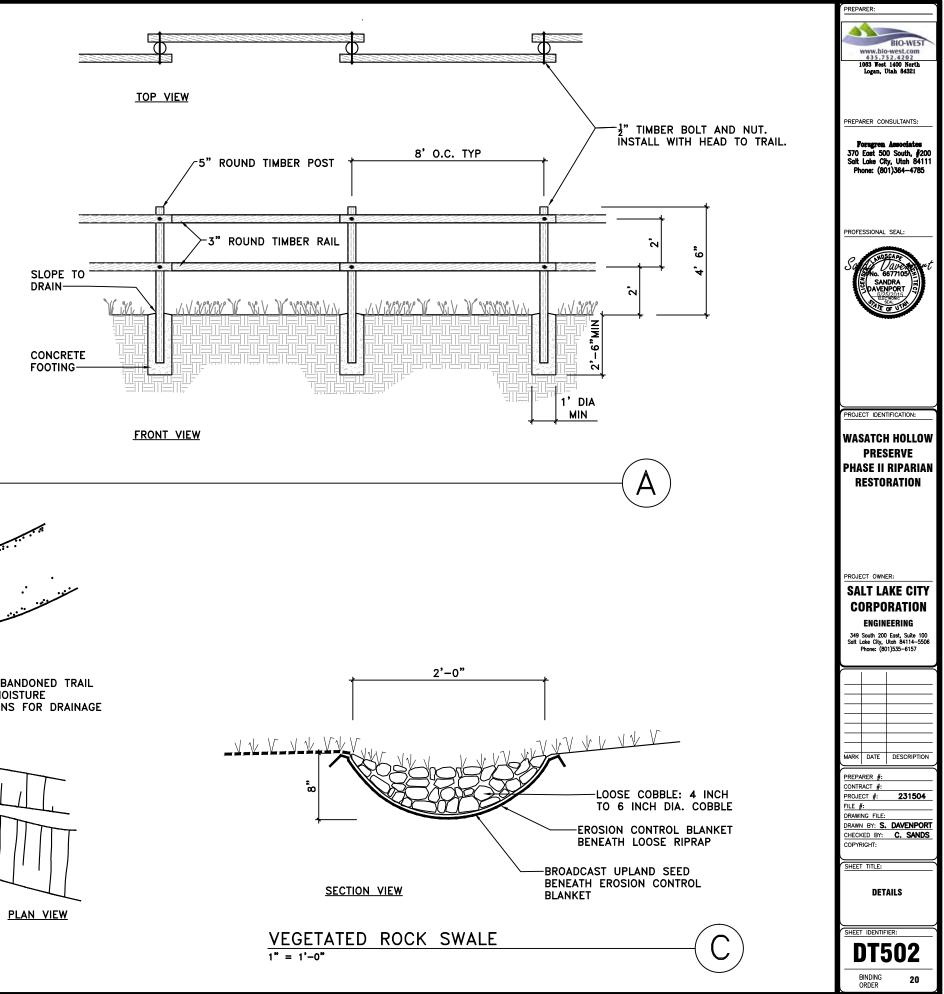
-3" ROUND TIMBER RAIL

5" ROUND TIMBER POST


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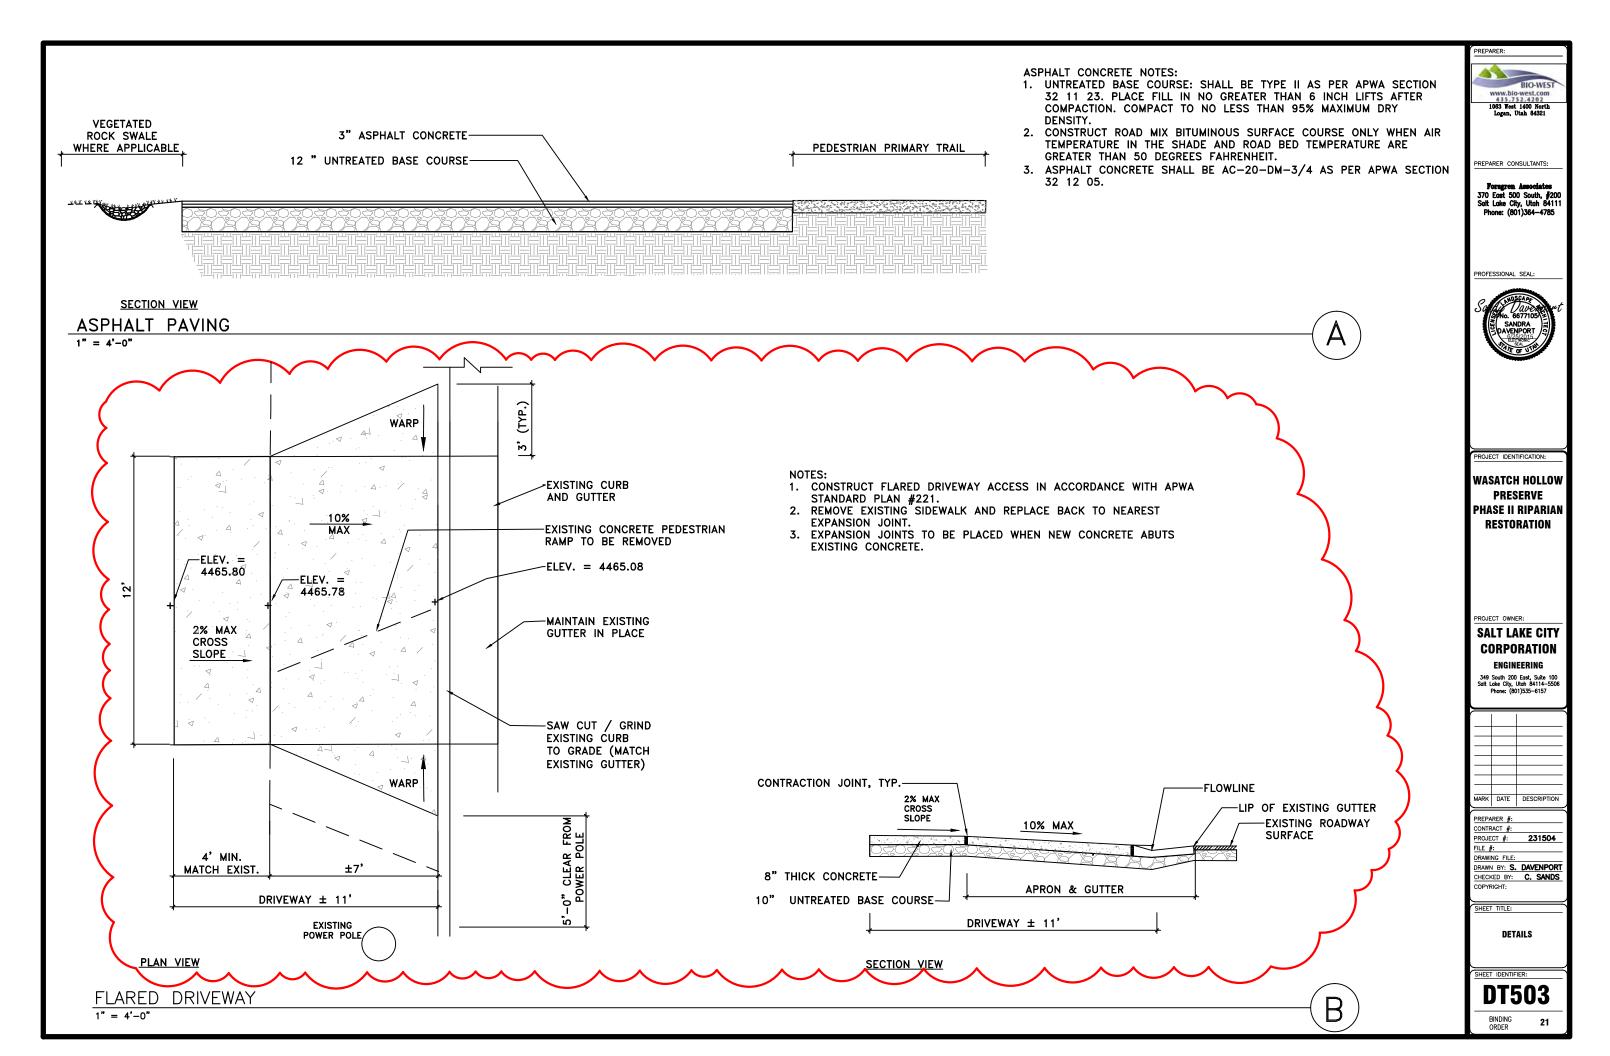
POST SIDE VIEW


3. USE ONLY GALVANIZED HARDWARE.










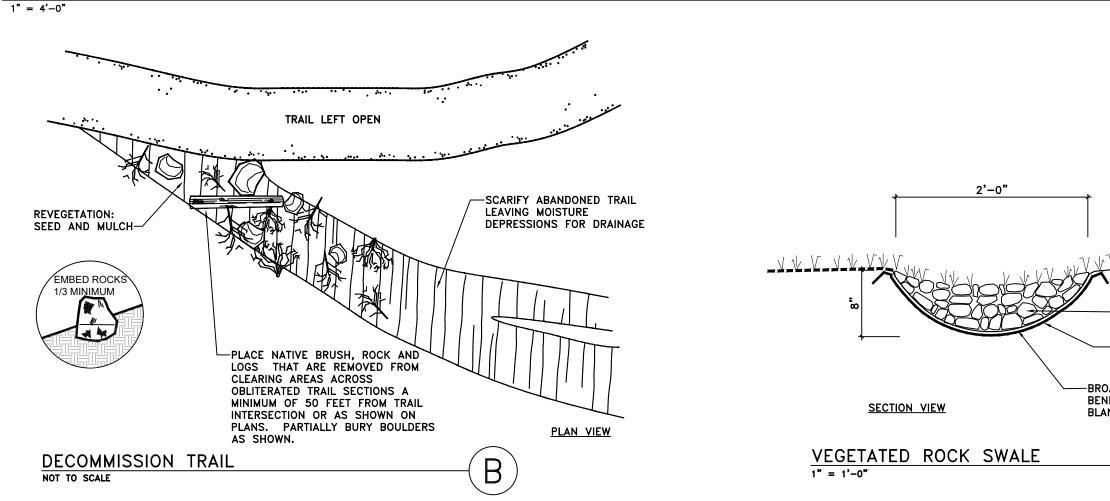

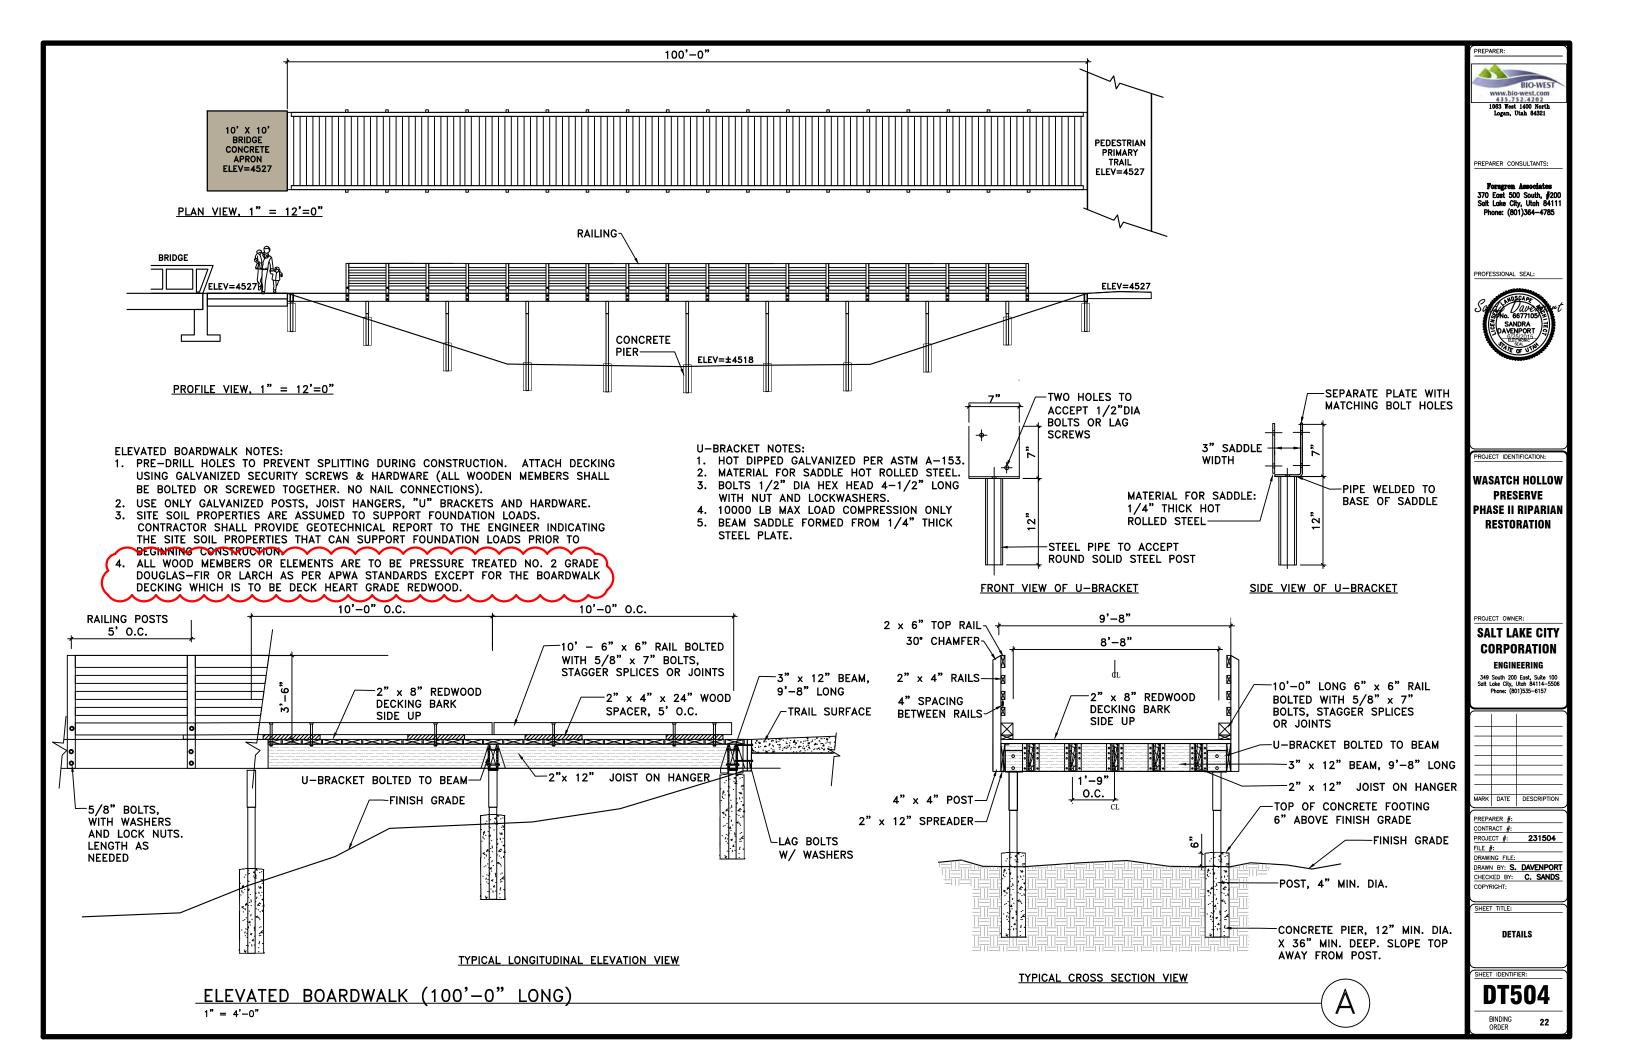

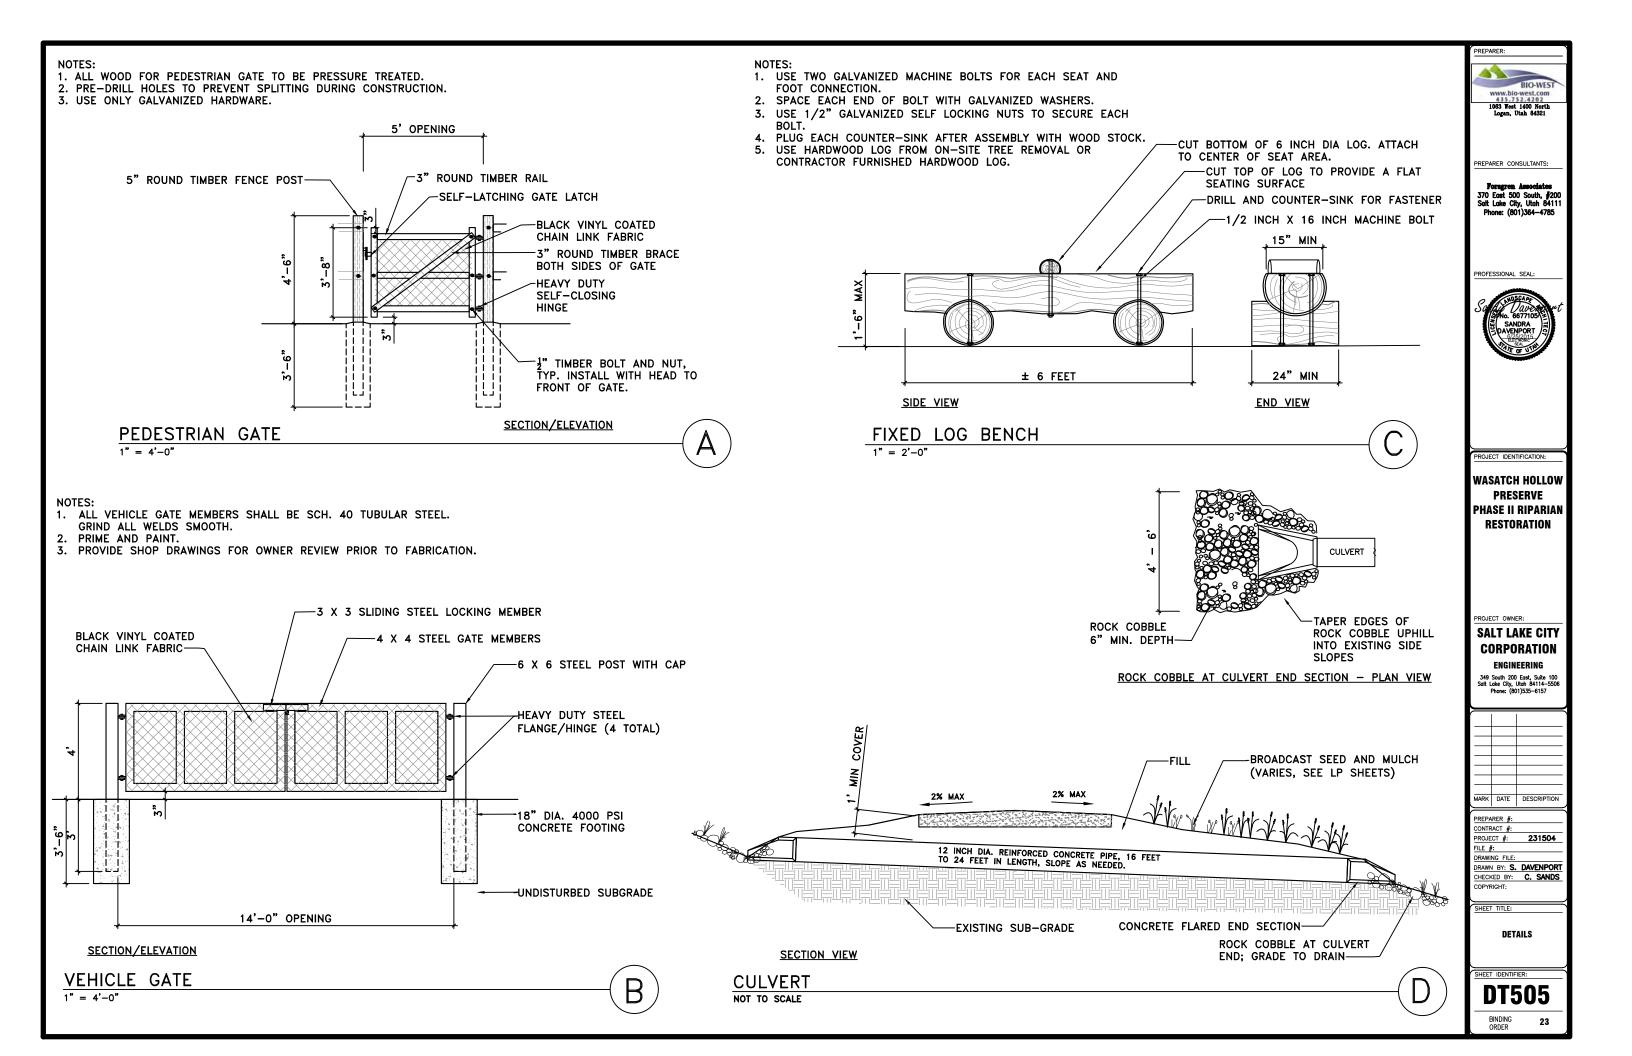

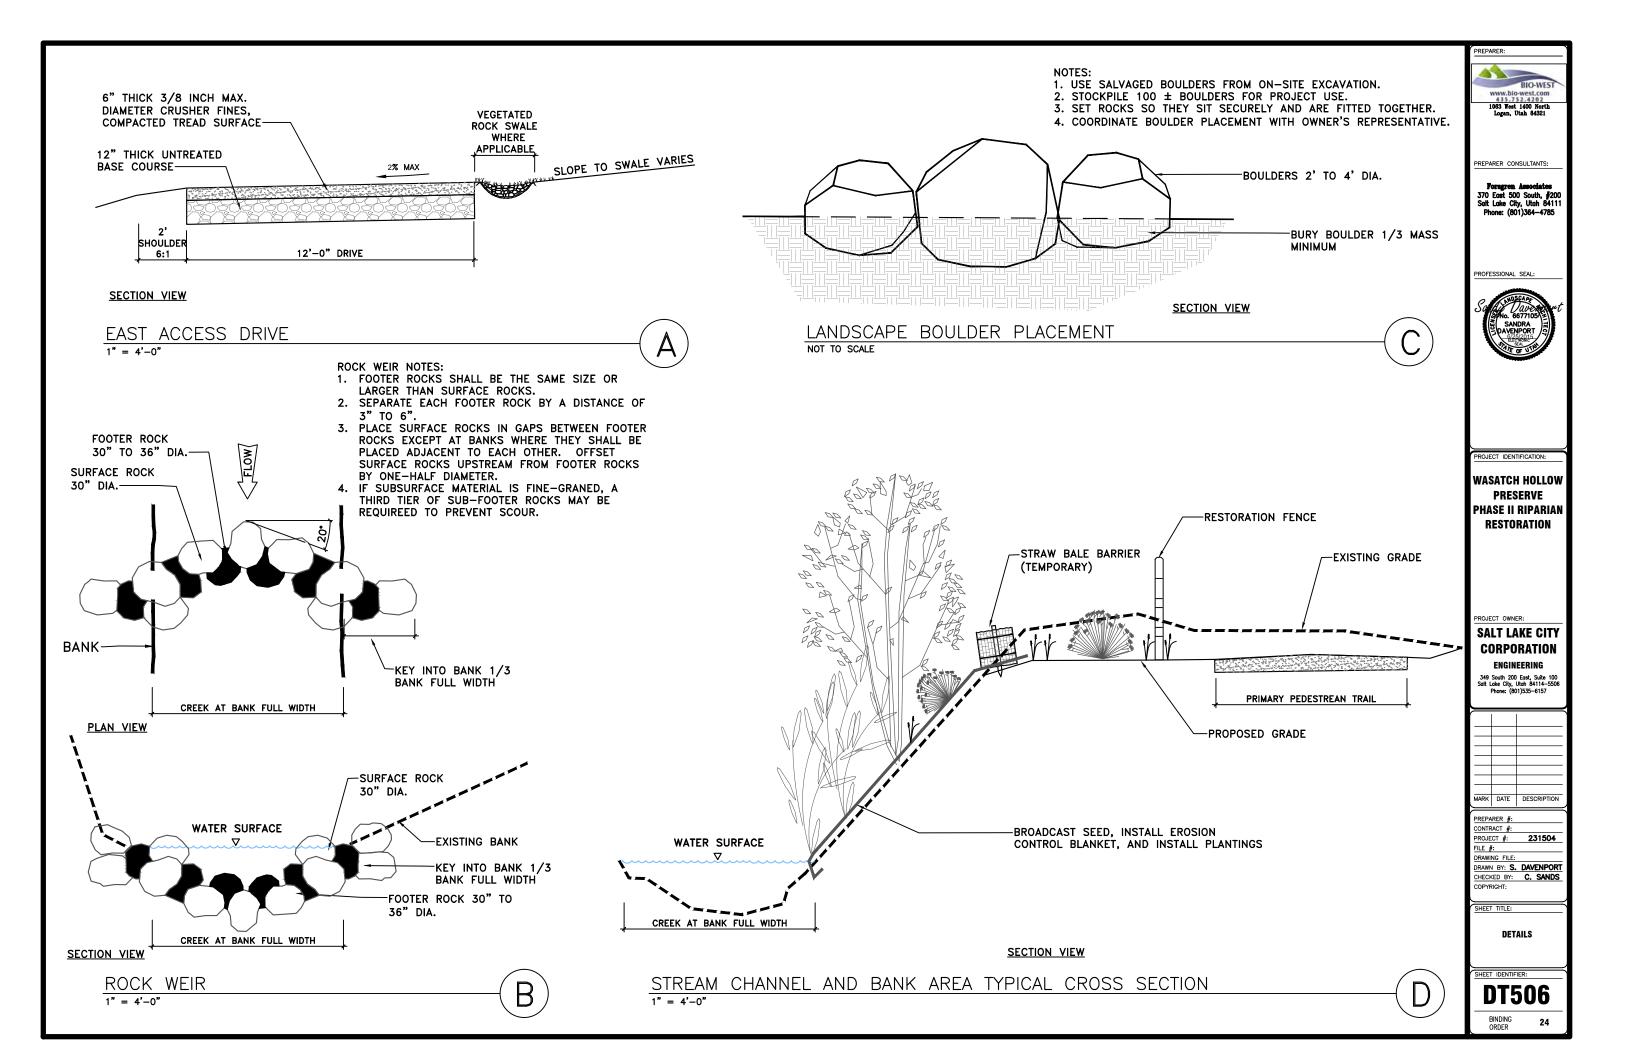

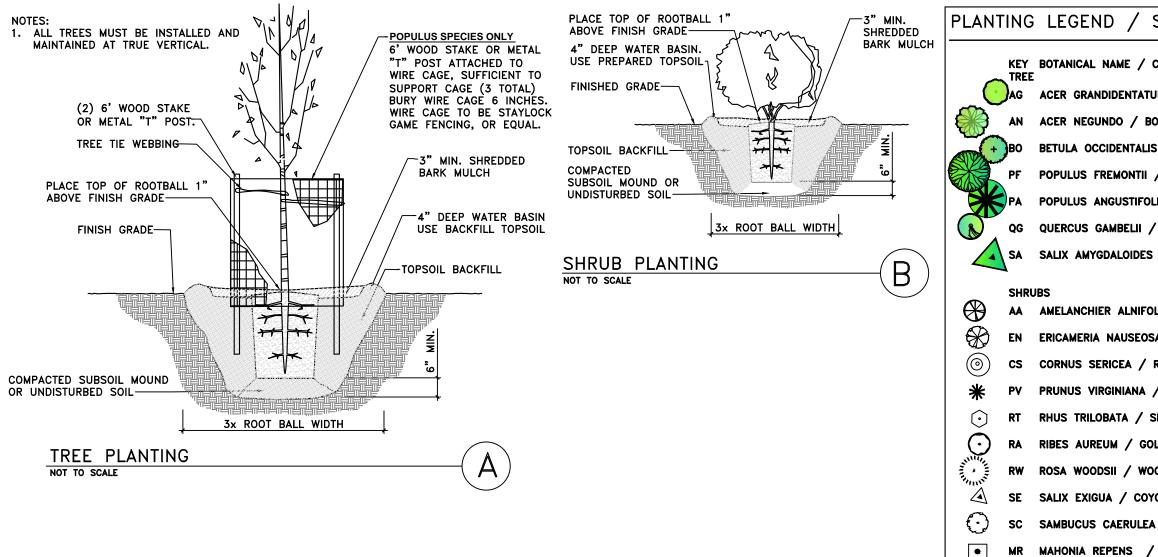


			BROADCAST SEED			SEED
SEED NO.	SPECIES NAME		Number of	Pounds of pure	Percent	Seeds per
	BOTANICAL NAME	COMMON NAME	seeds per pound	live seed per acre	of mix	square foot
1	Aristida purpurea	Purple three-awn	250,000	4	10.95%	23
2	Elymus elymoides	Bottlebrush squirreltail	192,000	4	8.41%	18
3	Stipa comata	Needle and thread grass	137,857	4	6.04%	13
4	Elymus trachycaulum	Slender wheatgrass	135,000	6	8.87%	19
5	Poa secunda (sandbergii)	Sandberg bluegrass	1,046,960	1	11.47%	24
6	Pseudoroegneria spicata	Bluebunch wheatgrass	125,680	2	2.75%	6
7	Balsamorhiza sagittata	Arrowleaf balsamroot	58,438	4	2.56%	5
8	Linum lewisii 'Appar'	Appar blue flax	294,848	4	12.92%	27
9	Erigeron speciosus	Aspen daisy	1,600,000	0.5	8.76%	18
10	Geranium viscosissimum	Wild geranium	55,238	2.5	1.51%	3
11	Heliomeris multiflora	Showy goldeneye	1,055,000	1	11.56%	24
12	Lupinus argenteus	Silvery lupine	126,000	2	2.76%	6
13	Wyethia amplexicaulis	Mule's ear	28,221	4	1.24%	3
14	Artemisia ludoviciana	Prairie sage	32,767	4	1.44%	3
15	Ericameria nauseosa	Rubber rabbitbrush	400,000	2	8.76%	18
	TOTAL			45	100.00%	210

RIPARIAN SEED MIX							
SEED NO.	SPECIES NAME			BROADCAST SEED			
			Number of seeds per	Pounds of pure	Percent	Seeds per	
	BOTANICAL NAME	COMMON NAME	pound	live seed per acre	1 1 1 1 1 1 1 1 1 1 1 1 1 1 1 1 1 1 1	square foot	
1	Carex rostrata	Beaked sedge	444,000	4	14.75%	41	
2	Carex nebrascensis	Nebraska sedge	534,100	4	17.75%	49	
3	Eleocharis palustris	Spikerush	754,000	4	25.05%	69	
4	Juncus arcticus	Baltic rush	3,000,000	1	24.92%	69	
5	Schoenoplectus acutus	Hardstem bulrush	206,400	5	8.57%	24	
6	Schoenoplectus americanus	Threesquare bulrush	179,800	6	8.96%	25	
	TOTAL			24	100.00%	276	


(

ING	LEGEND / SIZE / QUANTITI	ES	
KEY B	OTANICAL NAME / COMMON NAME	SIZE	QTY.
	CER GRANDIDENTATUM / BIGTOOTH MAPLE	2" CAL	30
AN A	CER NEGUNDO / BOX ELDER	2" CAL	28
во в	ETULA OCCIDENTALIS / RIVER BIRCH	2" CAL	15
PF P	OPULUS FREMONTII / FREMONT COTTONWOOD	2" CAL	23
PA P	OPULUS ANGUSTIFOLIA / NARROWLEAF COTT.	2" CAL	7
QG Q	UERCUS GAMBELII / GAMBEL OAK	2" CAL	46
SA S	ALIX AMYGDALOIDES / PEACHLEAF WILLOW	2" CAL	7
SHRUBS			
<b>AA</b> A	MELANCHIER ALNIFOLIA / SERVICEBERRY	5 GAL	17
EN E	RICAMERIA NAUSEOSA / RABBITBRUSH	5 GAL	90
cs c	ORNUS SERICEA / RED-OSIER DOGWOOD	5 GAL	60
PV P	RUNUS VIRGINIANA / CHOKECHERRY	5 GAL	49
RT R	HUS TRILOBATA / SKUNKBUSH	5 GAL	71
RA R	IBES AUREUM / GOLDEN CURRANT	5 GAL	61
RW R	OSA WOODSII / WOODS ROSE	5 GAL	26
SE S	ALIX EXIGUA / COYOTE WILLOW	1 GAL	123
sc s	AMBUCUS CAERULEA / BLUE ELDERBERRY	5 GAL	45
MR M	AHONIA REPENS / CREEPING MAHONIA	1 GAL	40
SA S	YMPHORICARPOS ALBUS / SNOWBERRY	5 GAL	10


PREPARER: BIO-WEST WWW.bio-WEST.com 415.752.4202 1068 Yest 1400 North Logan, Utah 84321				
PREPARER CONSULTANTS: Forngren Associates 370 East 500 South, #200 Sait Lake City, Utah 84111 Phone: (801)364-4785				
PROFESSIONAL SEAL:				
PROJECT IDENTIFICATION: WASATCH HOLLOW PRESERVE PHASE II RIPARIAN RESTORATION				
PROJECT OWNER: SALT LAKE CITY CORPORATION ENGINEERING 349 South 200 East, Suite 100 Salt Lake City, Utah 84114–5506 Phome: (801)535–6157				
MARK DATE DESCRIPTION				
PREPARER #: CONTRACT #: PROJECT #: PROJECT #: DRAWING FILE: DRAWING FILE: DRAWING BY: <b>S.</b> DAVENPORT CHECKED BY: <b>C.</b> SANDS COPYRIGHT:				
SHEET TITLE:				
DETAILS				

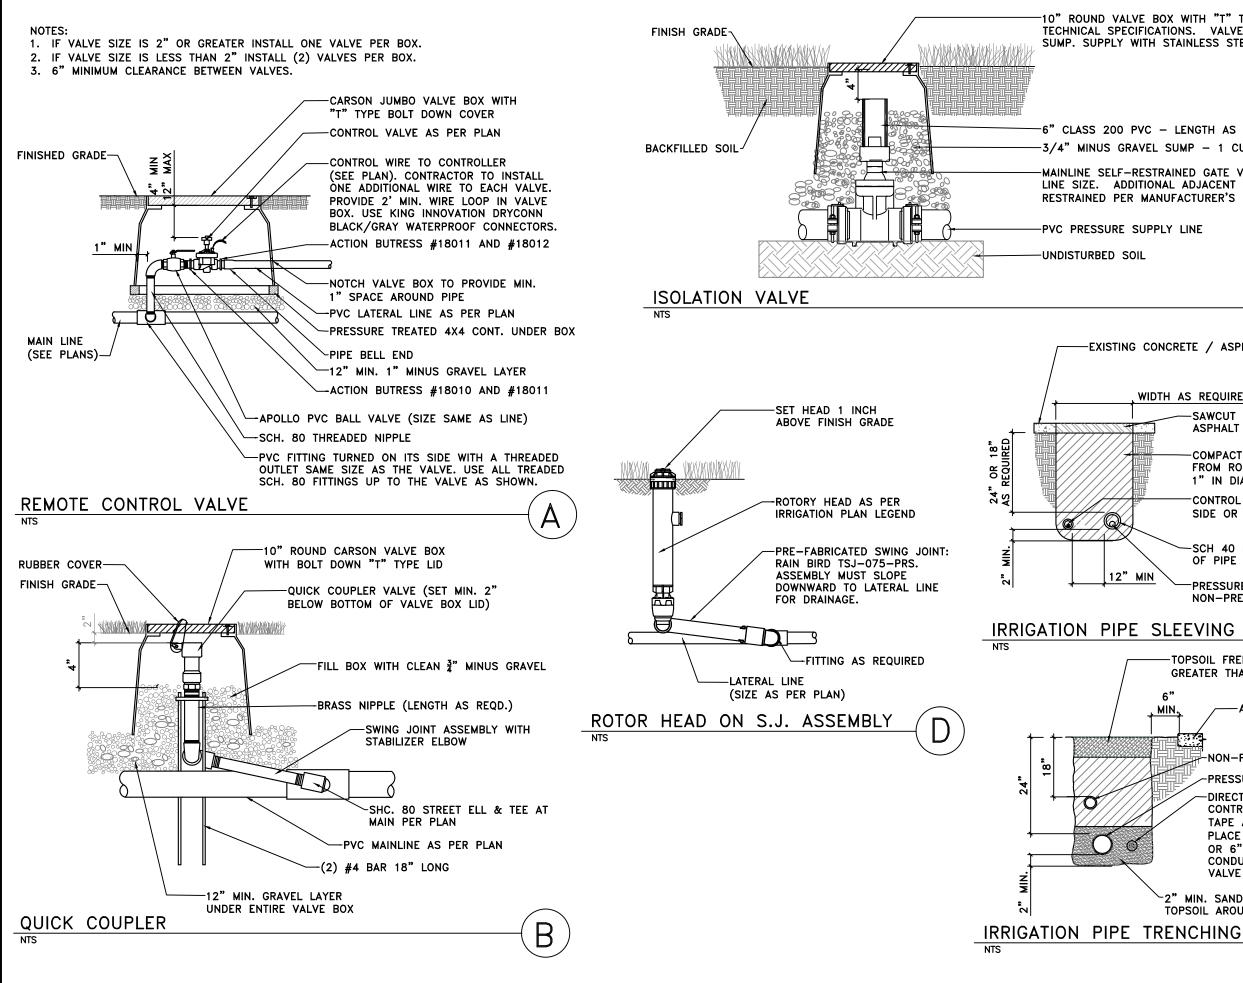

PARER 10" ROUND VALVE BOX WITH "T" TYPE BOLT DOWN LID PER 433 TECHNICAL SPECIFICATIONS. VALVE BOX TO REST ON GRAVEL BIO-WEST SUMP. SUPPLY WITH STAINLESS STEEL LOCKING BOLTS. www.bio-west.com 435.752.4202 1063 West 1400 North Logan, Utah 84321 REPARER CONSULTANTS: -6" CLASS 200 PVC - LENGTH AS REQUIRED Foragren Associates 370 East 500 South, #200 Salt Lake City, Utah 84111 Phone: (801)364-4785 -3/4" MINUS GRAVEL SUMP - 1 CU. FT. MAINLINE SELF-RESTRAINED GATE VALVE, LEEMCO LMV SERIES, LINE SIZE. ADDITIONAL ADJACENT JOINTS SHALL ALSO BE RESTRAINED PER MANUFACTURER'S RECOMMENDATIONS. ROFESSIONAL SEAL: -EXISTING CONCRETE / ASPHALT / TRAIL SURFACE WIDTH AS REQUIRED ROJECT IDENTIFICATION: -SAWCUT & PATCH CONCRETE OR ASPHALT AS REQUIRED WASATCH HOLLOW PRESERVE COMPACTED BACKFILL FREE PHASE II RIPARIAN FROM ROCKS GREATER THAN RESTORATION 1" IN DIAMETER. CONTROL WIRES 12" TO EITHER SIDE OR 6" UNDER MAINLINE. SCH 40 PVC PIPE. 2X DIAMETER OF PIPE TO BE SLEEVED ROJECT OWNER: SALT LAKE CITY PRESSURE MAIN LINE / NON-PRESSURE LATERAL LINE CORPORATION ENGINEERING 349 South 200 East, Suite 100 Salt Lake City, Utah 84114–550 Phone: (801)535–6157 TOPSOIL FREE FROM ROCKS GREATER THAN 1" DIAMETER 6' ADJACENT HARD SURFACE MIN. MARK DATE DESCRIPTION NON-PRESSURE LATERAL LINE REPARER #: -PRESSURE MAIN LINE CONTRACT #: PROJECT #: 231504 -DIRECT BURIAL, LOW VOLTAGE FILE #: CONTROL WIRES IN CONDUIT; DRAWING FILE DRAWN BY: S. DAVENPORT CHECKED BY: C. SANDS TAPE AND BUNDLE AT 10' O.C. PLACE 6" EITHER SIDE OF PIPE OR 6" BELOW. STOP THE SHEET TITLE: CONDUIT 2 FEET BEFORE EACH VALVE BOX. DETAILS 2" MIN. SAND OR ROCK FREE TOPSOIL AROUND PIPES HEET IDENTIFIER: **DT508** BINDING ORDER 26

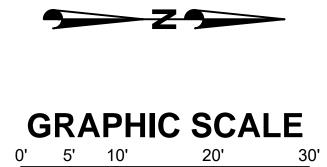

Scale: 1"=10'

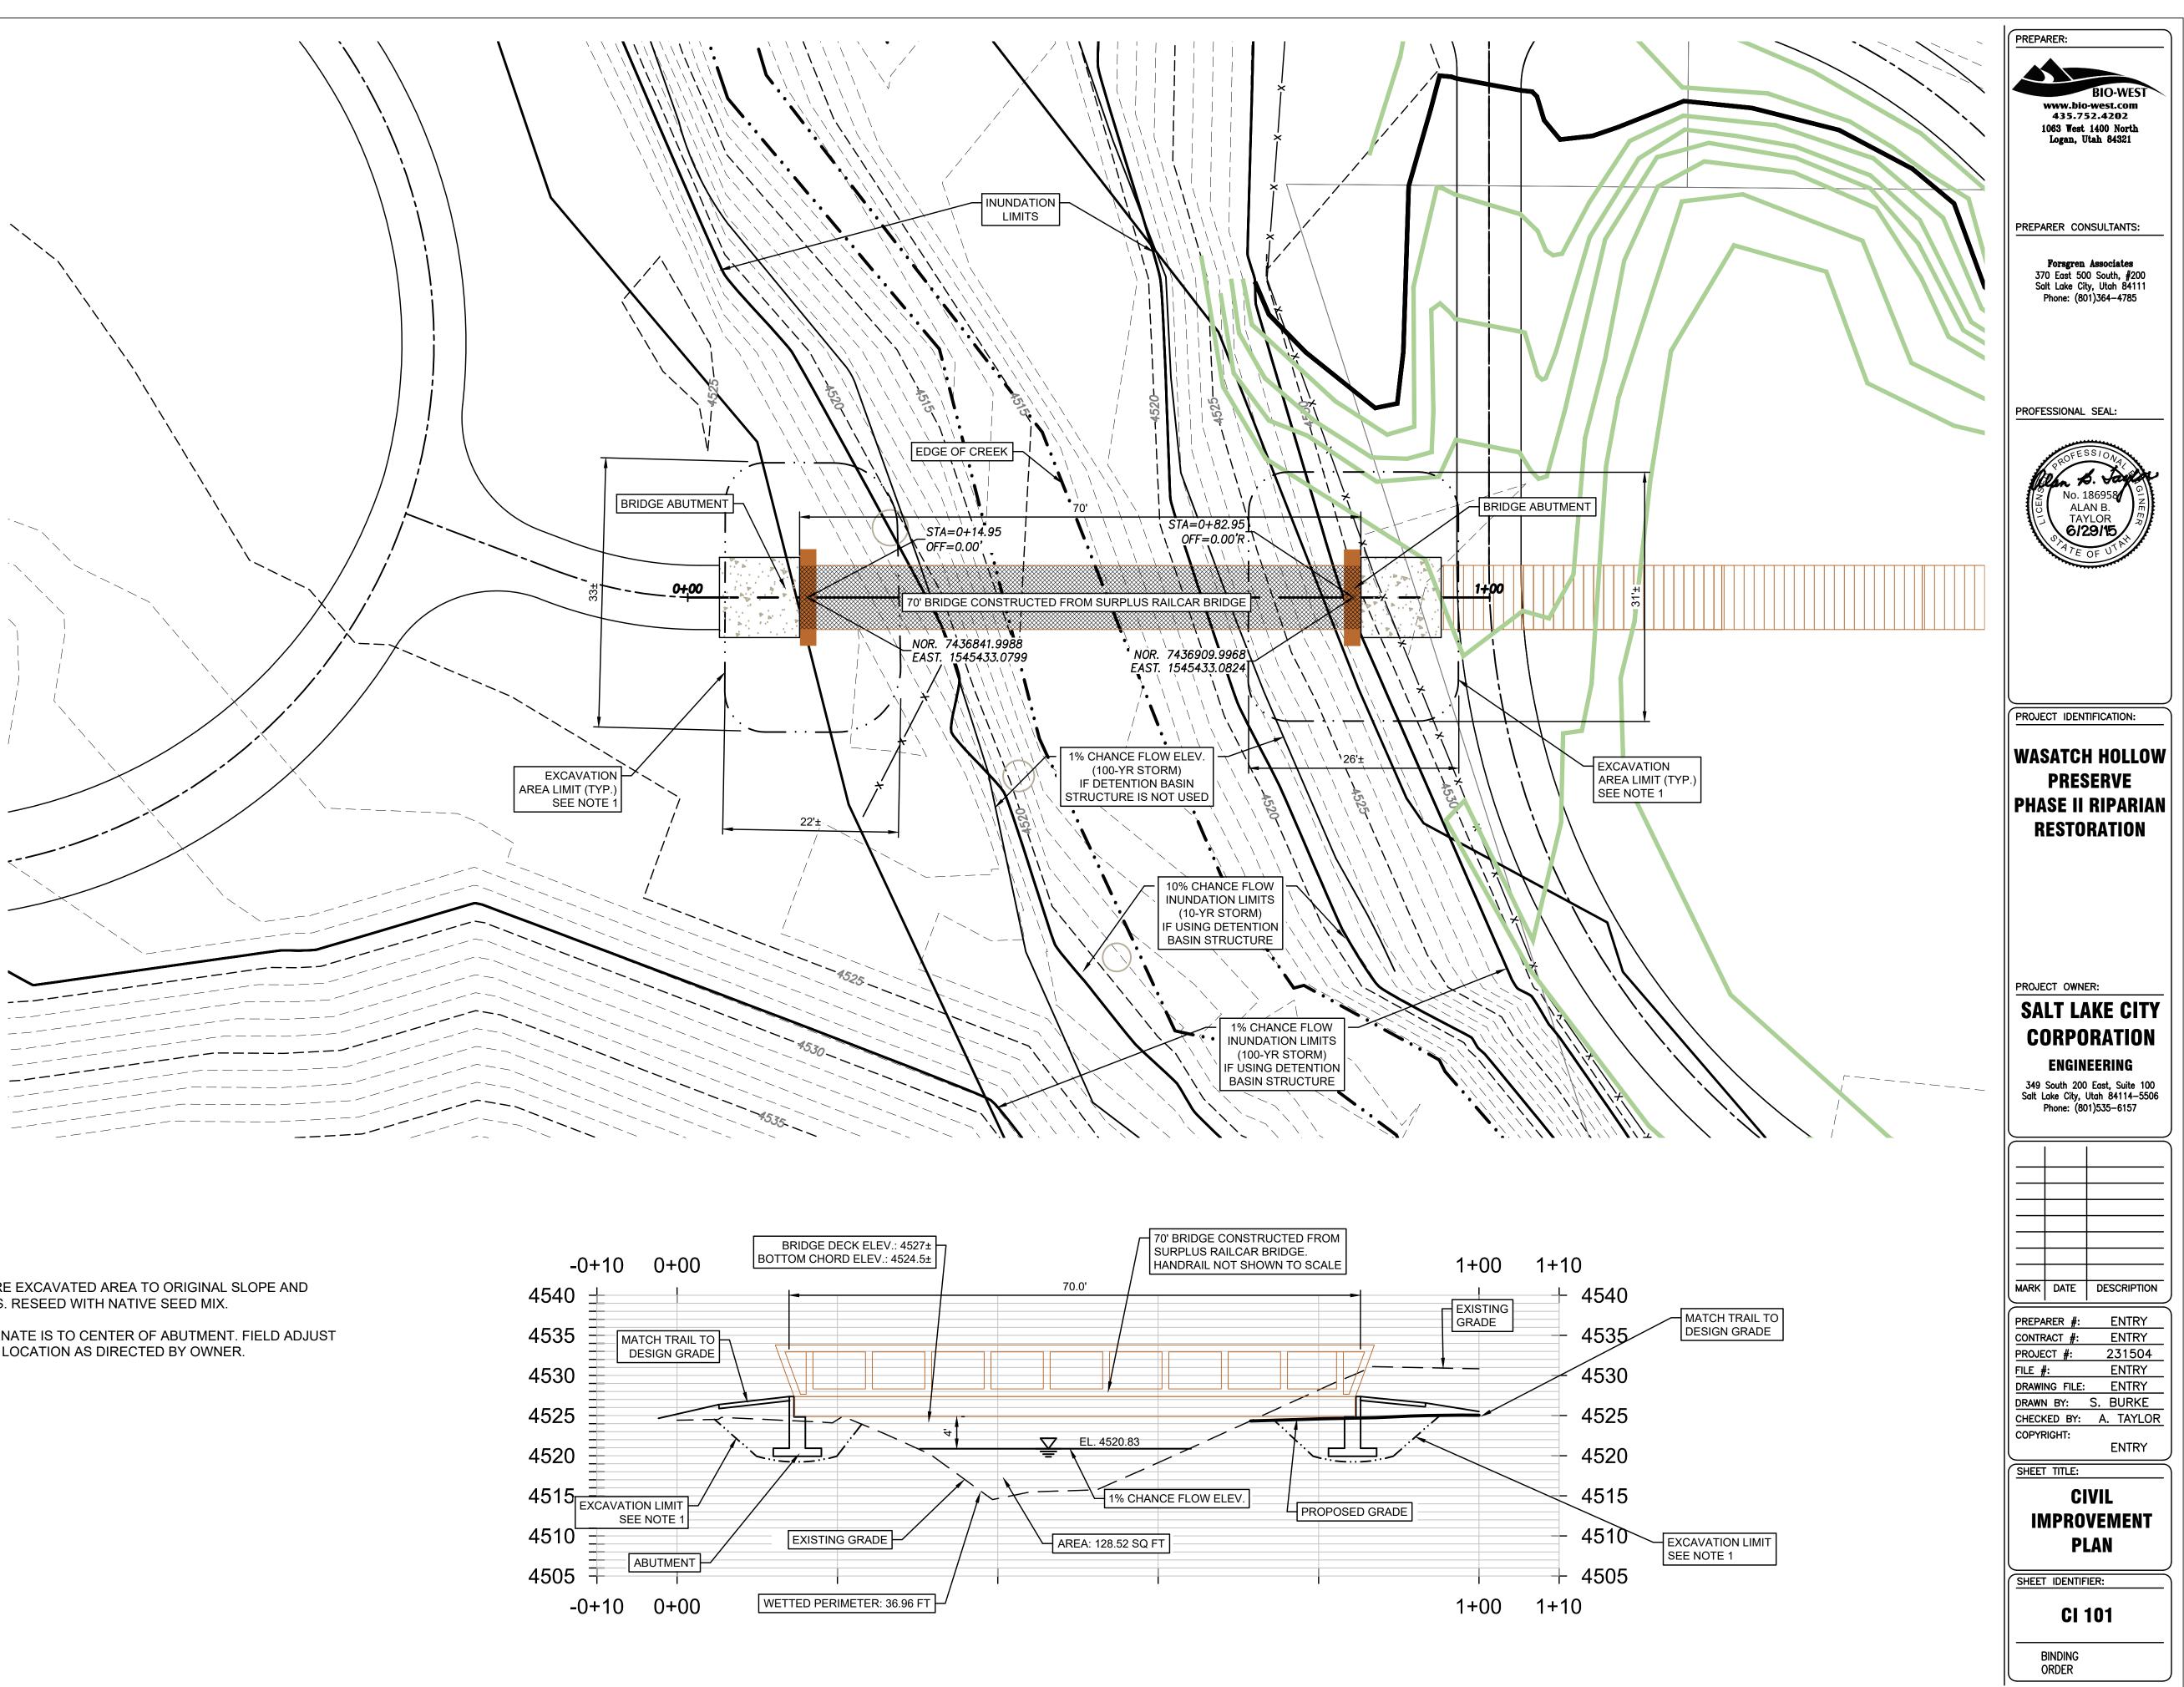

# NOTES:

- 1. RESTORE EXCAVATED AREA TO ORIGINAL SLOPE AND GRADES. RESEED WITH NATIVE SEED MIX.
- 2. COORDINATE IS TO CENTER OF ABUTMENT. FIELD ADJUST BRIDGE LOCATION AS DIRECTED BY OWNER.

