

Staff Report

PLANNING DIVISION DEPARTMENT of COMMUNITY and NEIGHBORHOODS

To: Salt Lake City Planning Commission

From: Amy Thompson, Senior Planner, amy.thompson@slcgov.com or 385-226-9001

Date: August 25, 2021

Re: Conditional Use (PLNPCM2021-00264) – Church at 1612-1624 S 1000 W

Conditional Use

PROPERTY ADDRESS: 1612-1624 S 1000 W

PARCEL ID: 15-14-252-013-0000 & 15-14-252-014-0000

MASTER PLAN: Westside

ZONING DISTRICT: RMF-35 (Residential Multi-Family)

REQUEST: Jeffery Gardner, the architect representing the Samoan Independent 7th Day Adventist Church, is requesting Conditional Use approval to construct a new building that will be used as a Place of Worship/Church at approximately 1612-1624 S 1000 W. The property is located in the RMF-35 (Residential Multi-Family) zoning district and a church is a Conditional Use in that zone.

RECOMMENDATION: Planning Staff finds the project generally meets the applicable standards of approval and therefore recommends the Planning Commission approve the Conditional Use for the church.

ATTACHMENTS:

- A. Vicinity Map
- B. Plans Submitted by Applicant
- C. Property and Vicinity Photos
- D. RMF-35 Zoning Standards
- E. Conditional Use Standards
- F. Public Process & Comments
- G. Department Review Comments

SALT LAKE CITY CORPORATION

451 SOUTH STATE STREET, ROOM 406 PO BOX 145480 SALT LAKE CITY. UT 84114-5480 WWW.SLCGOV.COM TEL 801-535-7757 FAX 801-535-6174

PROJECT DESCRIPTION:

Jeffery Gardner, of Architectural Nexus, representing the Samoan Independent 7th Day Adventist Church, is requesting conditional use approval for a new church building to be located at 1612-1624 South 1000 West in the RMF-35 -Residential Multi-Family zoning district. The proposed new church building includes a multi-function gym space which will also double as a chapel and sanctuary space. The project will also include two classrooms, a small kitchen and support spaces. Surface parking is provided for the project on the north portion of the parcel and is accessed from 1000 W.



Churches/Places of Worship in the RMF-35 zoning district require conditional use approval from the Planning Commission.



BACKGROUND:

The Planning Commission granted conditional use approval for the Samoan Independent 7th Day Adventist Church at this same location on August 8, 2018. The previous proposal was the same as the new proposal apart from the design of the new building, which has been revised. Conditional Use approvals are only valid for a year unless a building permit has been issued or complete building plans have been submitted. The Planning Commission can grant extensions on Conditional Use approvals; however, an extension was not requested prior to expiration of the approval and therefore a new Conditional Use application is required.

The project site is currently vacant; however, it was formerly occupied by this same proposed use - Samoan Independent 7th Day Adventist Church. The new upgraded building will better meet the needs of the congregation and the desired programing in that space. The former church building was demolished under building permit BLD2018-04639. The former church building was laid out on the

site in a similar fashion to the current proposal with the church on the south portion of the site and the parking on the north portion of the site.

KEY CONSIDERATIONS:

The key considerations and concerns below have been identified through the analysis of the project, and neighbor and community input.

- 1. Lot Consolidation
- 2. Neighborhood Compatibility and Impact

Consideration 1: Lot Consolidation

The RMF-35 zoning district requires a minimum lot width of 140 FT for a church use. The subject property consists of two adjacent parcels – 1612 S and 1624 S 1000 W. The parcel at 1612 S is approximately 50 FT wide and the parcel at 1624 S is approximately 137.7 FT wide. Consolidation of the parcels is required to meet the 140 FT lot width requirement in this zone for a church use. The applicants have submitted a lot consolidation application (petition PLNSUB2021-00553) that is currently being processed. This is an administrative application that can be approved by staff and does not require Planning Commission approval. Staff has noted this requirement in the next steps section of the staff report.

Consideration 2: Neighborhood Compatibility and Impact

The most recent use on the property was for a place of worship (church). The previous church building was demolished so it could be replaced by an upgraded building that would better meet the needs of the congregation and the desired programming in that space. The proposed use of the property as a church and anticipated impacts of the church use would not be significantly changing from what previously existed and was established on the site. The new facility is expected to continue to work compatibly within the context of its location.

NEXT STEPS:

Approval of Conditional Use

If the conditional use is approved, the applicant will be required to comply with all other department/division requirements and obtain all necessary building permits for the project.


In order to meet the 140 FT lot width requirement for a place of worship in the RMF-35 zone, a lot consolidation is required for the subject properties (1612 S 1000 W and 1624 S 1000 W) before the use can be established on the site.

Denial of Conditional Use

State and City code require that a Conditional Use be approved if reasonable conditions can be imposed on the use to mitigate any reasonably anticipated detrimental effects of the use. A conditional use can only be denied if the Planning Commission finds that reasonably anticipated detrimental effects cannot be mitigated with the imposition of reasonable conditions.

If the Planning requests are denied, the applicant would not be able to use the new building for a church. A new building could still be constructed but would have to be used for one of the permitted uses listed in 21A.33.020 of the zoning ordinance.

ATTACHMENT A – VICINITY MAP

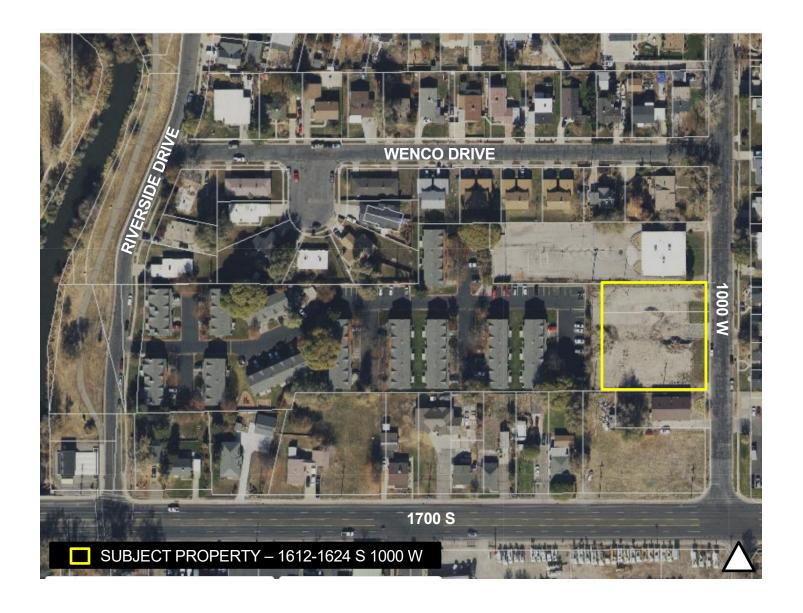

<u>ATTACHMENT B – PLANS SUBMITTED BY APPLICANT</u>

ARCHITECTURAL NEXUS, Inc archnexus.com



SALT LAKE CITY

2505 East Parleys Way Salt Lake City, Utah 84109 T 801.924.5000

SACRAMENTO

1990 Third Street, Suite 500 Sacramento, California 95811 T 916.443.5911

Samoan Independent Seventh Day Adventist Church

The original Samoan Independent Seventh Day Adventist Church (SISDAC) was located on the site referenced in this proposal at 1624 South 1000 West, Salt Lake City, UT 84104. The original building was not designed for the needs of this congregation and had outlived its useful life. Therefore, SISDAC was allowed under the previous building permit to demo the building with expectation that it would be replaced with new construction and a similar program. The demolition work was authorized by the city and completed prior to the project going on hold and the building permit expiration. Places of worship are accommodated in an RMF-35 Moderate Density Multi-Family Residential District as conditional uses, which is the purpose of this application.

The proposed project is a single story church building. It includes, a post-function/gym space which will double as a chapel/sanctuary space. The project will also include two classrooms, a small kitchen and support spaces. It is the intention of SISDAC to also construct a dedicated sanctuary space to the east as some undetermined time, under a separate building permit. The sanctuary work was originally proposed under the previous building permit and later removed. The sanctuary will remain outside the scope of the current project and all city applications.

The service and operation of the building will be the same as the original building.


The site to the north is occupied by another church, the Serbian Orthodox Church. The site to the west is occupied by a multi-family residential building. The sites to the south and east (across the street) are occupied by single /two family residential buildings.

There will not be any shift workers in the new building, and there will likely be 3-4 employees in the building at any one time.

The calculated occupancy load of the post-function / sanctuary space is 323 occupants with a total building occupancy of 342 occupants.

All the required setbacks and landscape buffers required are being met.

Site plans, building plans and elevations are attached

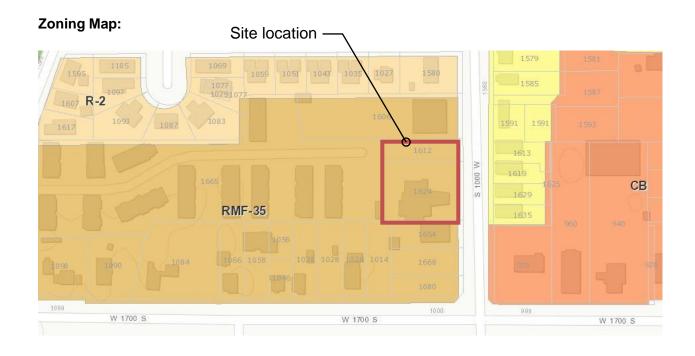

Existing Conditions: (Original building demolished under building permit: BLD2018-08342)







Please see Architectural Nexus' comments below in blue which address how the project, The Samoan Independent Seventh Day Adventist Church (SISDAC) meets each of the required Conditional Use Standards, the City Wide Master Plan, and the Neighborhood Master Plan (The Westside Master Plan) of the area where the project is located.

21A.54.080: STANDARDS FOR CONDITIONA USES:

A conditional use shall be approved if reasonable conditions are proposed, or can be imposed, to mitigate the reasonably anticipated detrimental effects of the proposed sue in accordance with applicable standards set forth in this section. If the reasonably anticipated detrimental effects of a proposed conditional use cannot be substantially mitigated by the proposal of the imposition of reasonable conditions to achieve compliance with applicable standards, the conditional use shall be denied.

- A. **Approval Standards:** A conditional use shall be approved unless the planning commission, or in the case of administrative conditional uses, the planning director or designee, concludes that the following standards cannot be met:
 - 1. The use complies with applicable provisions of this title;

Architectural Nexus 21.3.18: Places of worship fall under the conditional use category for the RMF-35 zone in which the proposed building is located. See response to question #3 and provided figures for additional information.

2. The use is compatible, or with conditions of approval can be made compatible, with surrounding uses;


Architectural Nexus 21.3.18: The proposed SISDAC project will be constructed on an existing church site in a place of a recently demolished church building. The previous building was removed with city approval per building permit BLD 2018-08342. The adjacent site to the north also has a church of similar sq. ft., height, and foot print. These two churches of different denominations serve the surrounding residents and provide a place for religious gatherings. The neighborhood is accustom to having a church on the site and it is our intention to continue using the site for the same use.

3. The use is consistent with applicable adopted city planning policies, documents, and master plans;

Architectural Nexus 21.3.18: The proposed site (1612 and 1624 below) is in the RMF-35 zone which allows church buildings within the zone as a conditional use. The proposed SISDAC building is a single level building that's max height is under the maximum height limit of 35'.

RMF-35

Moderate Density Multifamily Residential. The purpose of the RMF-35 moderate density multi-family residential district is to provide an environment suitable for a variety of moderate density housing types, including single-family, two-family, and multi-family dwellings with a maximum height of thirty five feet (35').

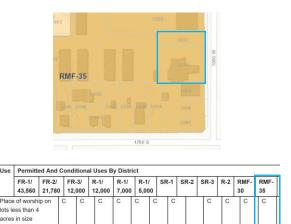

4. The anticipated detrimental effects of a proposed use can be mitigated by the imposition of reasonable conditions;

Architectural Nexus 21.3.18: We do not anticipate any detrimental effects linked to the proposed SISDAC project. The project is replacing an existing place of worship and will have typical hours of operation and use associated with a building of this nature. The project is also adjacent to another church building.

- B. **Detrimental effects determination:** In analyzing the anticipated detrimental effects of a proposed use, the planning commission, or in the case of administrative conditional uses, the planning director or designee, shall determine compliance with each of the following:
 - 1. This title specifically authorizes the use where it is located;

Architectural Nexus 21.3.18: The proposed site (1612 and 1624) is in the RMF-35 zone which allows church buildings within the zone as a conditional use. See response to question #3 and provided figures for additional information.

2. The use is consistent with applicable policies set forth in adopted city wide, community and small area master plans and future land use maps.

Architectural Nexus 21.3.18: The following summarizes how the SISDAC project meets and supports the SLC City Wide Master Plan.

The addition of the proposed SISDAC project to the community fabric will provide for a diverse mix of uses in the area, which is an underlying principle of the SLC City Wide masterplan. The proposed building will continue the site's legacy of being a place of worship for those in the community. The project supports the stated vision of the master plan in that in introduces and allows for a new religious denomination with an emphasis on a minority community. A quote from the SLC City Wide Master Plan states, "We expect to have true choices about how we live our

lives, from what kinds of home we live in, to how we travel to work, shop, worship, or recreate." The master plan lists several initiatives which we have integrated into the design of the proposed SISDAC project:

Compatibility – We have endeavored to provide the community with a project that will integrate into the surrounding context in terms of scale and character. The proposed building is of a similar foot print and height to the surrounding buildings. The rectilinear forms used integrate into the surrounding context. The material pallet of CMU and painted cement siding are visually compatible with the neighborhood. See question four for additional information and rendering.

Neighborhoods – It is our belief that places of worship can help build strong neighborhoods. The project will seek to create stability, provide a conveniently located place of worship, build diversity and encourage social interaction. This project will be the first Seventh Day Adventist Church in the area and the only church focused on the Samoan community. The project supports The Westside Master Plan in providing diverse places of worship distributed throughout the neighborhoods.

Growth – The SISDAC project will support the mixed use goal, infill a now otherwise empty lot, and contribute to the healthy lifestyles of those in the community.

Transportation and mobility – As previously stated, SISDAC is the only denomination of its type in the area and the only church focused on the Samoan community. This project will reduce travel out of the community to find a Seventh Day Adventist Church while possibly bringing new people and families into the area. Bringing new people into the area could help support the proposed nearby Westside Master Plan regional node at 900 west and 1700 south.

Beautiful City - Places of worship are naturally people focused. The proposed SISDAC project has been designed to be people oriented. The design is conscious of the surrounding environment and as such the design does not drastically alter the site. Parking and entrances have been kept in the same locations to mitigate disturbances. The building has been pulled back from the road to provide a larger landscaped buffer zone. The building is designed using high building standards, which call for the use of long lasting materials that are complementary to the surrounding building stock.

Arts and Culture – The SISDAC denomination associated with the proposed project will provide a place for the Samoan minority community. The introduction of this proposed project into the community will bring with it opportunities for diversity and the appreciation for new cultures.

This project supports the 3rd largest minority population in the Westside according to The Westside Master Plan.

Equity – As stated previously, the new project will allow the community to welcome a new denomination to the area and provide equal access to a more diverse choice of forms of worship.

3. The use is well suited to the character of the site, and adjacent uses as shown by an analysis of the intensity, size, and scale of the use compared to existing uses in the surrounding area;

Architectural Nexus 21.3.18: The proposed site is adjacent to another church building to the North (Right) and a residence to the south (Left) as shown below. The project is well suited to the character of the site and relative to the intensity, size, and scale of the use compared to the existing surrounding uses. The building steps down in size as it approaches the street in order to create a better transition to the surrounding neighborhood and human scale.

See the illustration below which shows the proposed building on the site in relation to the surrounding buildings.



4. The mass, scale, style, design and architectural detailing of the surrounding structures as they relate to the proposed have been considered;

Architectural Nexus 21.3.18: The mass and scale have been considered relative to the surrounding building. The materials used on the main taller portion of the building is CMU with the lower portion of the building being painted fiber cement board paneling and fiber cement board. The style design and architectural detailing are intended to create a distinct building identity while still blending in with the surrounding structures.



5. Access points and driveways are designed to minimize grading of natural topography, direct vehicular traffic onto major streets and not impede traffic flows;

Architectural Nexus 21.3.18: Existing driveways are utilized for vehicular access to the new project. The parking area for the most part has been maintained in the same location. There should be minimal regrading associated with the new project. Vehicular traffic and parking will remain in the same configuration as the previous church building and parking. The existing driveways and access points will be used and will not impede traffic flow. The existing driveways and access points will continue to direct traffic onto major streets.

6. The internal circulation system is designed to mitigate adverse impacts on adjacent property from motorized, non-motorized, and pedestrian traffic;

Architectural Nexus 21.3.18: The proposed project design has maintained many of the past site element locations such as parking and drive isles. We do not expect to see any adverse impacts regarding parking or pedestrian and vehicular traffic flow.

7. The site is designed to enable access and circulation for pedestrian and bicycles;

Architectural Nexus 21.3.18: The proposed SISDAC project facilitates
pedestrian and bicycle access with a separate access point protecting them
from vehicular obstacles. Bicycle racks have also been provided on site and
adjacent to the building.

8. Access to the site does not unreasonably impact the service level of any abutting or adjacent street;

Architectural Nexus 21.3.18: The site's layout and use have remained largely unchanged and will not impact the service level of any abutting or adjacent street.

9. The location and design of off street parking complies with applicable standards of this code:

Architectural Nexus 21.3.18: Off street parking has been provided in accordance with applicable requirements. See the excerpt for sheet AS101 from the provided drawings. See the provided drawings for additional information.

PARKING DATA: REQUIRED PARKING CALCULATIONS 8 6 GYM (3 stalls / 1,000 of @ 2,542 sf); 8 A ALL OTHER AREAS (3 stalls / 1000 of @ 2,324 sf); 7 REQUIRED ADA STALLS (1 ada / 25 stalls); 1 TOTAL REQUIRED STALLS 16 PROPOSED PARKING 5 EXISTING STALLS 0 NEW STANDARD STALLS 21 NEW ADA STALLS 2 TOTAL PROVIDED PARKING 23

10. Utility capacity is sufficient to support the use at normal service levels;

Architectural Nexus 21.3.18: The uses and size of the building are similar to what it was previously and the utility capacity is sufficient to support the use at normal service levels.

11. The use is appropriately screened, buffered, or separated for adjoining dissimilar uses to mitigate potential use conflicts;

Architectural Nexus 21.3.18: The proposed project building respects the required building setbacks. The project also includes a decorative security fencing as well a dumpster enclosure to secure and screen the dumpsters. See the included drawings for additional information.

12. The use meets city sustainability plans, does not significantly impact the quality of surrounding air and water, encroach into a river or stream, or introduce any hazard or environmental damage to any adjacent property, including cigarette smoke;

Architectural Nexus 21.3.18: The project will not significantly impact the air, water or encroach into a river or stream. Likewise the project will not introduce any hazardous environmental damage to any adjacent properties. The project provide value to the community and its residents.


13. The hours of operation and delivery of the use are compatible with surrounding uses;

Architectural Nexus 21.3.18: The proposed project will not have hours of operation outside of that which is typical for a place of worship. There will be no shift work associated with the project.

14. Signs and lighting are compatible with, and do not negatively impact surrounding uses; and

Architectural Nexus 21.3.18: The lighting and signage are minimal. Most signage is kept to the building and at a reasonable size, with no monument signs. The majority of signage is code related. Lighting is mostly kept to the

parking lot and building entrances to provide safety and security for those accessing the site. See the included drawings for additional information.

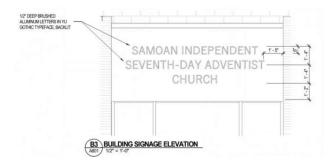

15. The proposed use does not undermine preservation of historic resources and structures.

Architectural Nexus 21.3.18: The proposed building does not undermine preservation of historic resources or structures and will be built on an empty site. The original building was recently demolished with the consent of the governing body per the listed building permit, BLD 2018-08342.

- C. **Conditions Imposed:** The planning commission, or in the case of administrative conditional uses, the planning director or the director's designee, may impose on a conditional use any conditions necessary to address the foregoing factors which may include, but are not limited to:
 - 1. Conditions on the scope of the use: its character, location, hours and methods of operation, architecture, signage, construction, landscaping, access, loading and parking, sanitization, drainage and utility, fencing and screening, and setbacks; and
 - 2. Conditions needed to mitigate any natural hazard; assure public safety; address environmental impacts; and mitigate dust, fumes, smoke, odor, noise vibrations; chemicals, toxins, pathogens, gases, heat, light and radiation.
- D. **Denial of Conditional Use:** A proposed conditional use shall be denied if:
 - 1. The proposed use is unlawful; or
 - 2. The reasonably anticipation detrimental effects of the proposed conditional use cannot be substantially mitigated as proposed in the conditional use application or by the imposition of reasonable conditions to achieve compliance with applicable standards set forth in this section.
- E. **Notice of Decision:** The planning commission, or in the case of administrative conditional use, the planning director or designee, shall provide written notice of the decision, including all conditions imposed to the applicant and local community council within (10) days of the final action. If the conditional use is approved, this notice shall be recorded against the property by the city recorder. (Ord. 14-12, 2012)

Owner Project #:

Architectural NEXUS, Inc. 2505 East Parleys Way Salt Lake City, UT 84109 T 801.924.5000

SAMOAN INDE

SAMOAN INDEPENDENT SEVENTH-DAY ADVENTIST CHURCH

SISDAC UTAH

1624 S 1000 W SALT LAKE CITY, UT 84104

Nexus Project #: 18030.1

02/17/20

PERMIT SET

APPROVALS

Date Signer 3 Date Signer 4 Date Date



Signer 1 Signer 2 Date Revision



PERMIT SET

NEXUS PROJECT #: 18030.1 CHECKED BY: AA AA RS 02/17/20 DRAWN BY: DATE:

COVER SHEET

G001

Samoan Independent Seventh-Day Adventist Church

PHONE: 385.775.0313

PHONE: 801.924.5000

1624 S 1000 W Salt Lake City, UT 84104

OWNER

CONTACT: Marilyn Spizzirri-Patu

E-MAIL: mpatu.secretaryutah@gmail.com INTERNET:

ARCHITECT Architectural NEXUS, Inc.

2505 East Parleys Way Salt Lake City, UT 84109 aarbuckle@archnexus.com CONTACT: Aaron Arbuckle

E-MAILgregory.nelson@crsengineers.com STRUCTURAL

4246 S Riverboat Rd, Ste 200 Salt Lake City, UT 84123

ARW Engineers 1594 Park Circle Ogden, Utah 84404

1220 S 300 W Salt Lake City, UT 84101

CONTACT: Mansour Aghdasi PHONE: 801.486.2222

BENJAMIN L. DAVIS

CONTACT: Greg Nelson

PHONE: 801.359.5565

CONTACT: Josh Blazzard JoshB@arwengineers.com INTERNET: PHONE: 801.782.6008 **MECHANICAL VBFA** 330 South 300 East Salt Lake City, UT 84111 E-MAIL: bdavis@vbfa.com INTERNET: **ELECTRICAL EELD**

mansour@ee-ld.com INTERNET:

SECTION DETAILS SECTION DETAILS

MILLWORK DETAILS

DOOR DETAILS

WINDOW TYPES

WINDOW DETAILS

TYPICAL DETAILS

FINISH SCHEDULE

FINISH FLOOR PLAN

SIGNAGE

ROOF AND PARAPET DETAILS

ROOF AND PARAPET DETAILS

DOOR SCHEDULE & TYPES

A520

A701

AI600

LOCATION





ARCH NEXUS Architectural NEXUS, Inc. 2505 East Parleys Way Salt Lake City, UT 84109 T 801.924.5000 http://www.archnexus.com Original drawings remain the property of the Architect and as such the Architect retains total ownership and control. The design represented by these drawings is sold to the client for

a one time use, unless otherwise agreed upon in writing by the © Architectural Nexus, Inc. 2017

Date Revision

ICC/ANSI A117.1-2009 INTERNATION FUEL GAS CODE 2015 EDITION 2018 EDITION 2018 EDITION DEFERRED SUBMITTALS 2018 EDITION 2018 EDITION SEE BELOW 2018 EDITION 2018 EDITION Zoning Ordinance

OTHER CRITERIA

DEFERRED SUBMITTAL LIST TO INCLUDE:

WATER MAINS (PRIVATE & PUBLIC), WATER LATERALS, STAND PIPES, FIRE HYDRANTS, AUTOMATIC FIRE SPRINKLER SYSTEMS, AND FIRE ALARM SYSTEMS. THE AUTOMATIC SMOKE DETECTION SYSTEMS IS PART OF THE FIRE ALARM SYSTEM. FIRE PERMITS SHALL BE IN ACCORDANCE WITH IFC SECTION 105.1.1 THROUGH 105.7.16.

OTHER DEFFERRED SUBMITTALS INCLUDE:

OPEN WEB JOISTS & GIRDERS

DESIGN CRITERIA

INTERNATIONAL ENERGY CONSERVATION CODE

APPLICABLE CODES

INTERNATIONAL BUILDING CODE

INTERNATIONAL MECHANICAL CODE

INTERNATIONAL PLUMBING CODE

ZONING ORDINANCE: ... Enter City.

INTERNATIONAL FIRE CODE

NATIONAL ELECTRICAL CODE

ACCESSIBILITY CODE

PRE-MANUFACTURED WOOD TRUSSES, BLOCKING, BRIDGING, BRIDGING CONNECTIONS, TRUSS HANGERS, AND RELATED COMPONENTS COLD FORMED STEEL STUDS / JOISTS / HEADERS / JAMBS / TRUSSES

SEISMIC BRACING OF ALL ARCHITECTURAL, MECHANICAL, PLUMBING, AND ELECTRICAL ITEMS WHERE REQUIRED BY ASCE 7-10 AND THE PROJECT CONTRACT DOCUMENTS

DISPLACEMENT RAMMED AGGREGATE PIERS.

PERMIT SET

NEXUS PROJECT #: 18030.1 CHECKED BY: Checker DRAWN BY: **Author** DATE: 02/17/20

GENERAL INFORMATION

GLASS-FIBER-REINFORCED

GYPSUM WALL BOARD

GLASS-FIBER-REINFORCED GYPSUM

INSIDE DIAMETER; INSIDE DIMENSION

GAUGE

GALV

HPT

INFO

LLH

LLV

LPT

MFR

MIN

NTS

 $^{\circ}$

OPP

PLAS

PR

PSF

MECH

GALVANIZED

CONCRETE

GLASS

GYPSUM

HIGH

HOSE BIBB

HIGH POINT

HOLLOW METAL

HEADER

HOUR

HEIGHT

INCH

INFORMATION

INTERIOR

JANITOR

(NOT USED)

LABORATORY

LONG LEG HORIZONTAL

LONG LEG VERTICAL

LAVATORY

LOW POINT

MACH RM MACHINE ROOM

MAXIMUM

MECHANICAL

MEZZANINE

MINIMUM

NOMINAL

NOT TO SCALE

ON CENTER

OUTSIDE DIAMETER;

OUTSIDE DIMENSION

POUNDS PER SQUARE INCH

POUNDS PER SQUARE FOOT

POLYVINYL CHLORIDE

OVERFLOW DRAIN

OVERHEAD DOOR

OPPOSITE HAND

OPPOSITE

ORIGINAL

P LAM PLASTIC LAMINATE

PLASTER

QUARRY TILE

PLUMB PLUMBING

PAIR

MANUFACTURER

MASONRY OPENING

NOT APPLICABLE

NOT IN CONTRACT

POUNDS

AIR CONDITIONING

ABOVE FINISHED CEILING

ABOVE FINISHED FLOOR

AIR HANDLING UNIT

AREA DRAIN

ALUMINUM

ANODIZED

ARCHITECT

BOARD

BUILDING

CELSIUS

COAT HOOK

CORNER GUARD

CONTROL JOINT

CENTERLINE

CEILING

CLOSET

CLEAR

COLUMN

CONCRETE

CORRIDOR

DEEP

DEGREE

DEMOLITION

DIAMETER

DIMENSION

DOWNSPOUT

EXPANSION JOINT

EXTERIOR INSULATION AND FINISH

DRAWINGS

ELEVATION

ELECTRICAL

ELEVATOR

EQUAL

EQUIPMENT

EXISTING

EXPOSED

EXTERIOR

FAHRENHEIT

FIRE ALARM

FLOOR DRAIN

FINISH GRADE

FOUNDATION

FINISH **FLOOR**

FIRE EXTINGUISHER

FIRE HOSE CABINET

FINISHED OPENING

FACE OF CONCRETE

FACE OF MASONRY FACE OF STUD

FIBER REINFORCED GYPSUM

FACE OF WALL

FIRE STANDPIPE

FIELD VERIFY

FEET

EDGE OF SLAB

EXISTING ROOF DRAIN

ELECTRIC WATER COOLER

FIRE ALARM CONTROL PANEL

FIRE EXTINGUISHER CABINET

FIRE DEPARTMENT CONNECTION

DOWN

EACH

CONTINUOUS

CERAMIC TILE

CONSTRUCTION JOINT

CABINET UNIT HEATER

DRINKING FOUNTAIN

CONTRACTOR FURNISHED,

CONTRACTOR INSTALLED

CONTINUOUS INSULATION

CONCRETE MASONRY UNIT

BOTTOM OF

anod

ARCH

BD

CL

CLG

CLO

CLR

COL

CONC

CONT

CORR

CTJ

DEG

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DN

DS

DWGS

ELEC

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ERD

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EQUIP

EWC

EXIST

EXP

EXT

FD

FE

FG

FHC

FIN

FO

FOC

FOM

FOW

FSP

FT

FV

RISER OR RADIUS

REFLECTED CEILING PLAN

RADIUS

ROOF DRAIN

REQUIRED

REVISION

ROOM

REFRIDGERATOR

RELATIVE HUMIDITY

RAIN WATER LEADER

SMOKE DETECTOR

SCHEDULE

SPECIFICATION

STAINLESS STEEL

SECTION

SIMILAR

STANDARD

TREAD

THICK

TELEPHONE

TEMPORARY

TOP OF CONCRETE

TOP OF MASONRY

TOP OF PARAPET

TOP OF WALL

TYPICAL

TOP OF

VERTICAL

VESTIBULE

WITH WITHOUT

WOOD

X,Y,Z (NOT USED)

WALL HYDRANT

WORKING POINT

THE PRECEDING LIST OF ABBREVIATIONS

IS PRESENTED AS A GENERAL GUIDE AND

GENERALLY ACCEPTED ABBREVIATIONS

MAY BE FOUND AMONG THE DRAWINGS -

MAY NOT BE USED WITHIN THIS DRAWING

SOME ABBREVIATIONS SHOWN ABOVE

DOES NOT NECESSARILY SHOW ALL

ABBREVIATIONS USED. OTHER

WEATHER RESISTIVE BARRIER

VERIFY IN FIELD

TOP OF SLAB; TOP OF STEEL

UNDERWRITER'S LABORATORIES

UNLESS NOTED OTHERWISE

VINYL COMPOSITE TILE

STRUCT STRUCTURAL

SELF ADHESIVE MEMBRANE

ROUGH OPENING

ROOF TOP UNIT

RAD

RCP

REF

REV

RM

RO

SCHED

SECT

SIM

SPEC

STD

TEMP

THK

TOC

TOM

TOP

TOS

TOW

TYP

TO

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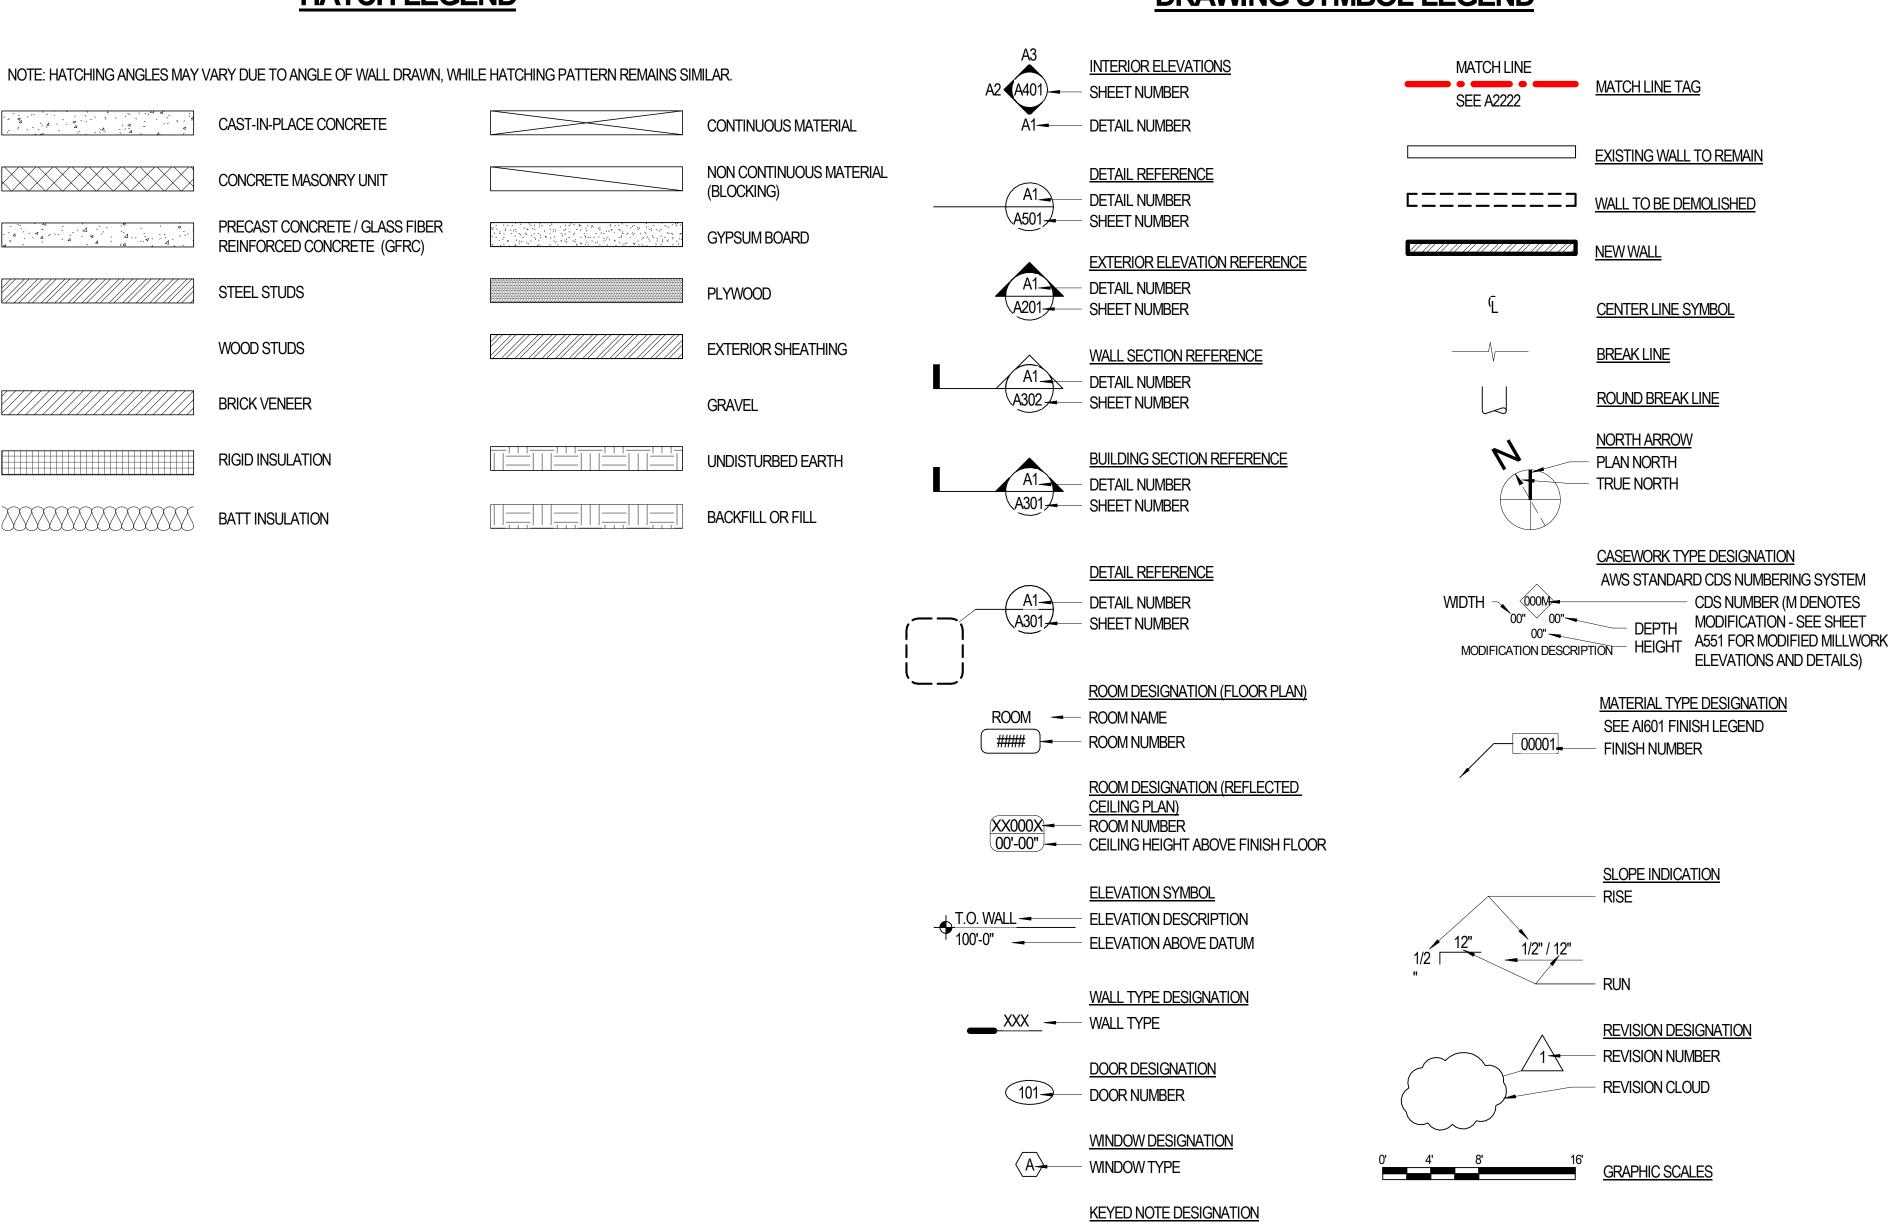
SET.

SS

REQD

HATCH LEGEND

DRAWING SYMBOL LEGEND



KEY NOTE NUMBER

00001 — EQUIPMENT NUMBER

— GLASS TYPE

EQUIPMENT DESIGNATION

GLASS TYPE DESIGNATION

ARCH NEXUS

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http://www.archnexus.com

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NDENT ADVE

Date Revision

PERMIT SET

NEXUS PROJECT #: 18030.1 CHECKED BY: Checker DRAWN BY: Author DATE: 02/17/20

GENERAL INFORMATION

G003

- A. SEE WALL TYPES ON FLOOR PLANS AND RATED WALL ASSEMBLIES ON SHEET G004a FOR SPECIFIC WALL CONSTRUCTION TO ACHIEVE THE RATINGS SHOWN ON THIS PLAN.
- B. REQUIRED MEANS OF EGRESS AND FIRE PROTECTION SYSTEMS SHALL BE MAINTAINED DURING CONSTRUCTION AND DEMOLITION OF THE Building.
- C. PER IFC CHAPTER 33, DURING CONSTRUCTION, ALTERATIONS, OR DEMOLITION, EXTINGUISHERS SHALL BE PROVIDED AT EACH STAIRWAY ON ALL FLOOR LEVELS WHERE COMBUSTIBLE MATERIALS HAVE ACCUMULATED, IN EVERY STORAGE AND CONSTRUCTION SHED, AND WHERE SPECIAL HAZARDS EXIST INCLUDING, BUT NOT LIMITED TO, THE STORAGE AND USE OF FLAMMABLE AND COMBUSTIBLE LIQUIDS.



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Date Revision 1 2/12/19 CCD 01

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NEXUS PROJECT #: 18030.1

EXITING AND

OCCUPANCY

Checker Author 02/17/20

CHECKED BY: DRAWN BY: DATE:

PLANS

G101

EXITING AND OCCUPANCY LEGEND

NO FIRE RATING 1 HOUR RATING 2 HOUR RATING


NO FIRE RATING 1 HOUR RATING


2 HOUR RATING


NO FIRE RATING 1 HOUR RATING

2 HOUR RATING

SOLID CONCRETE

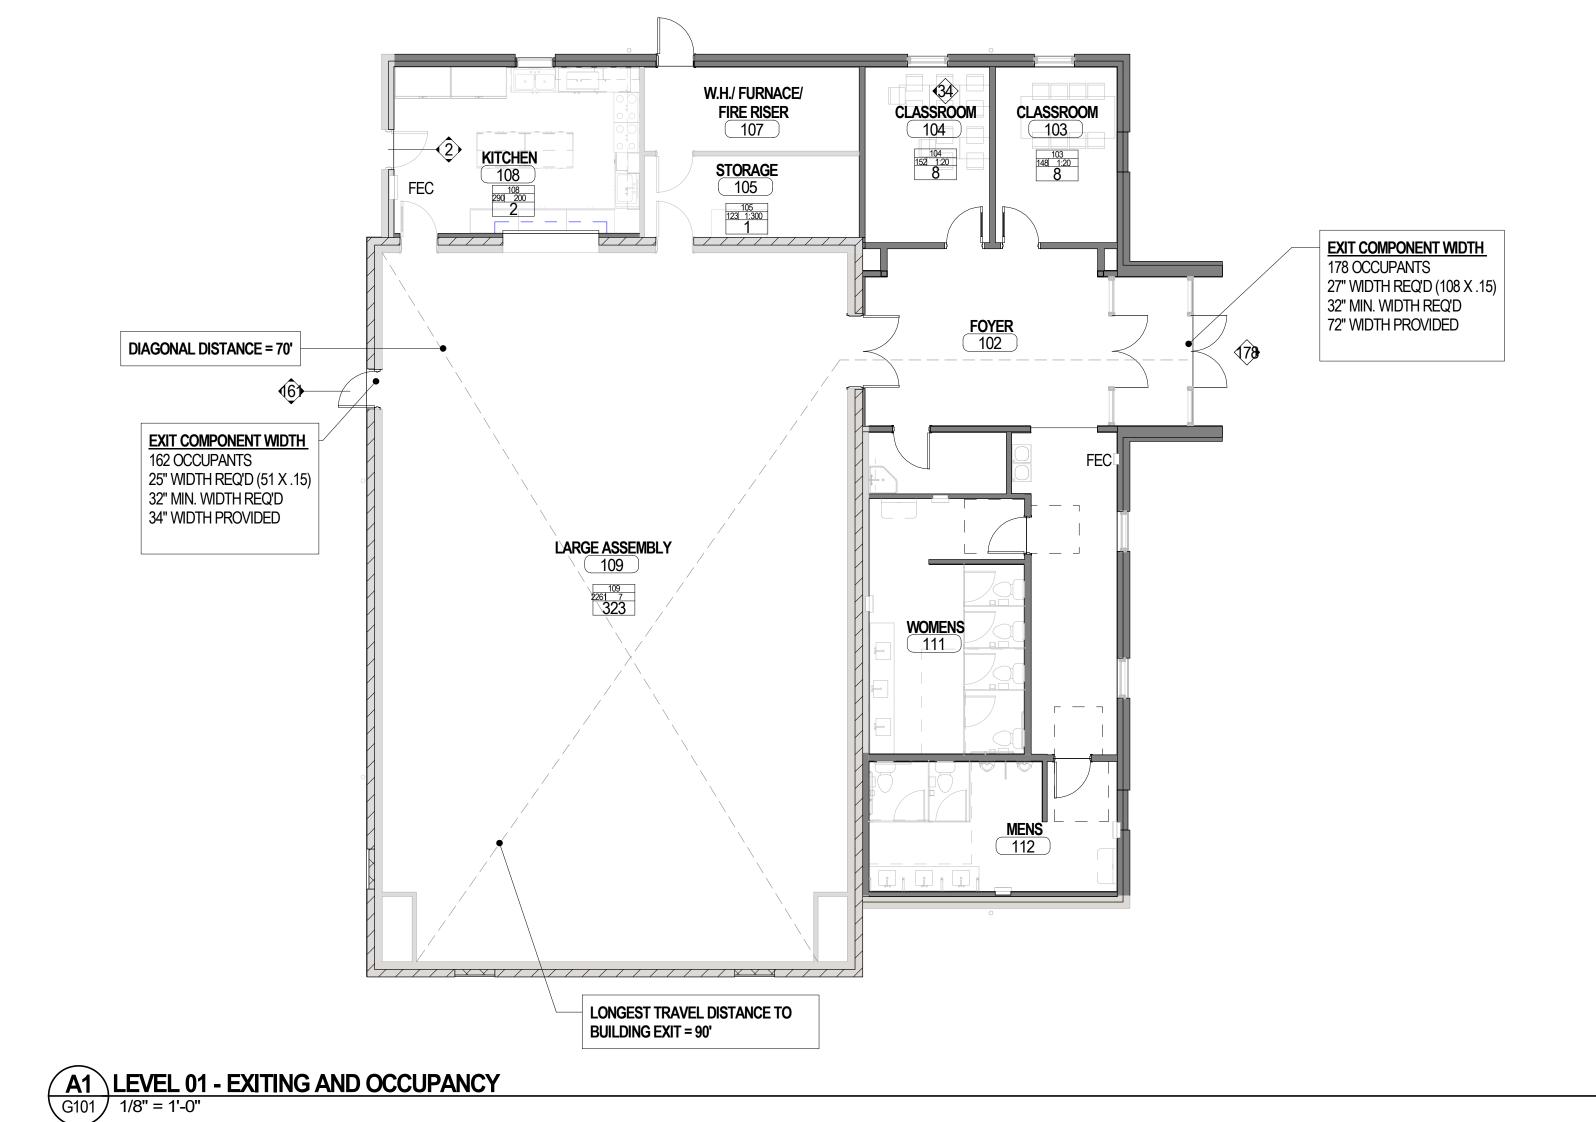

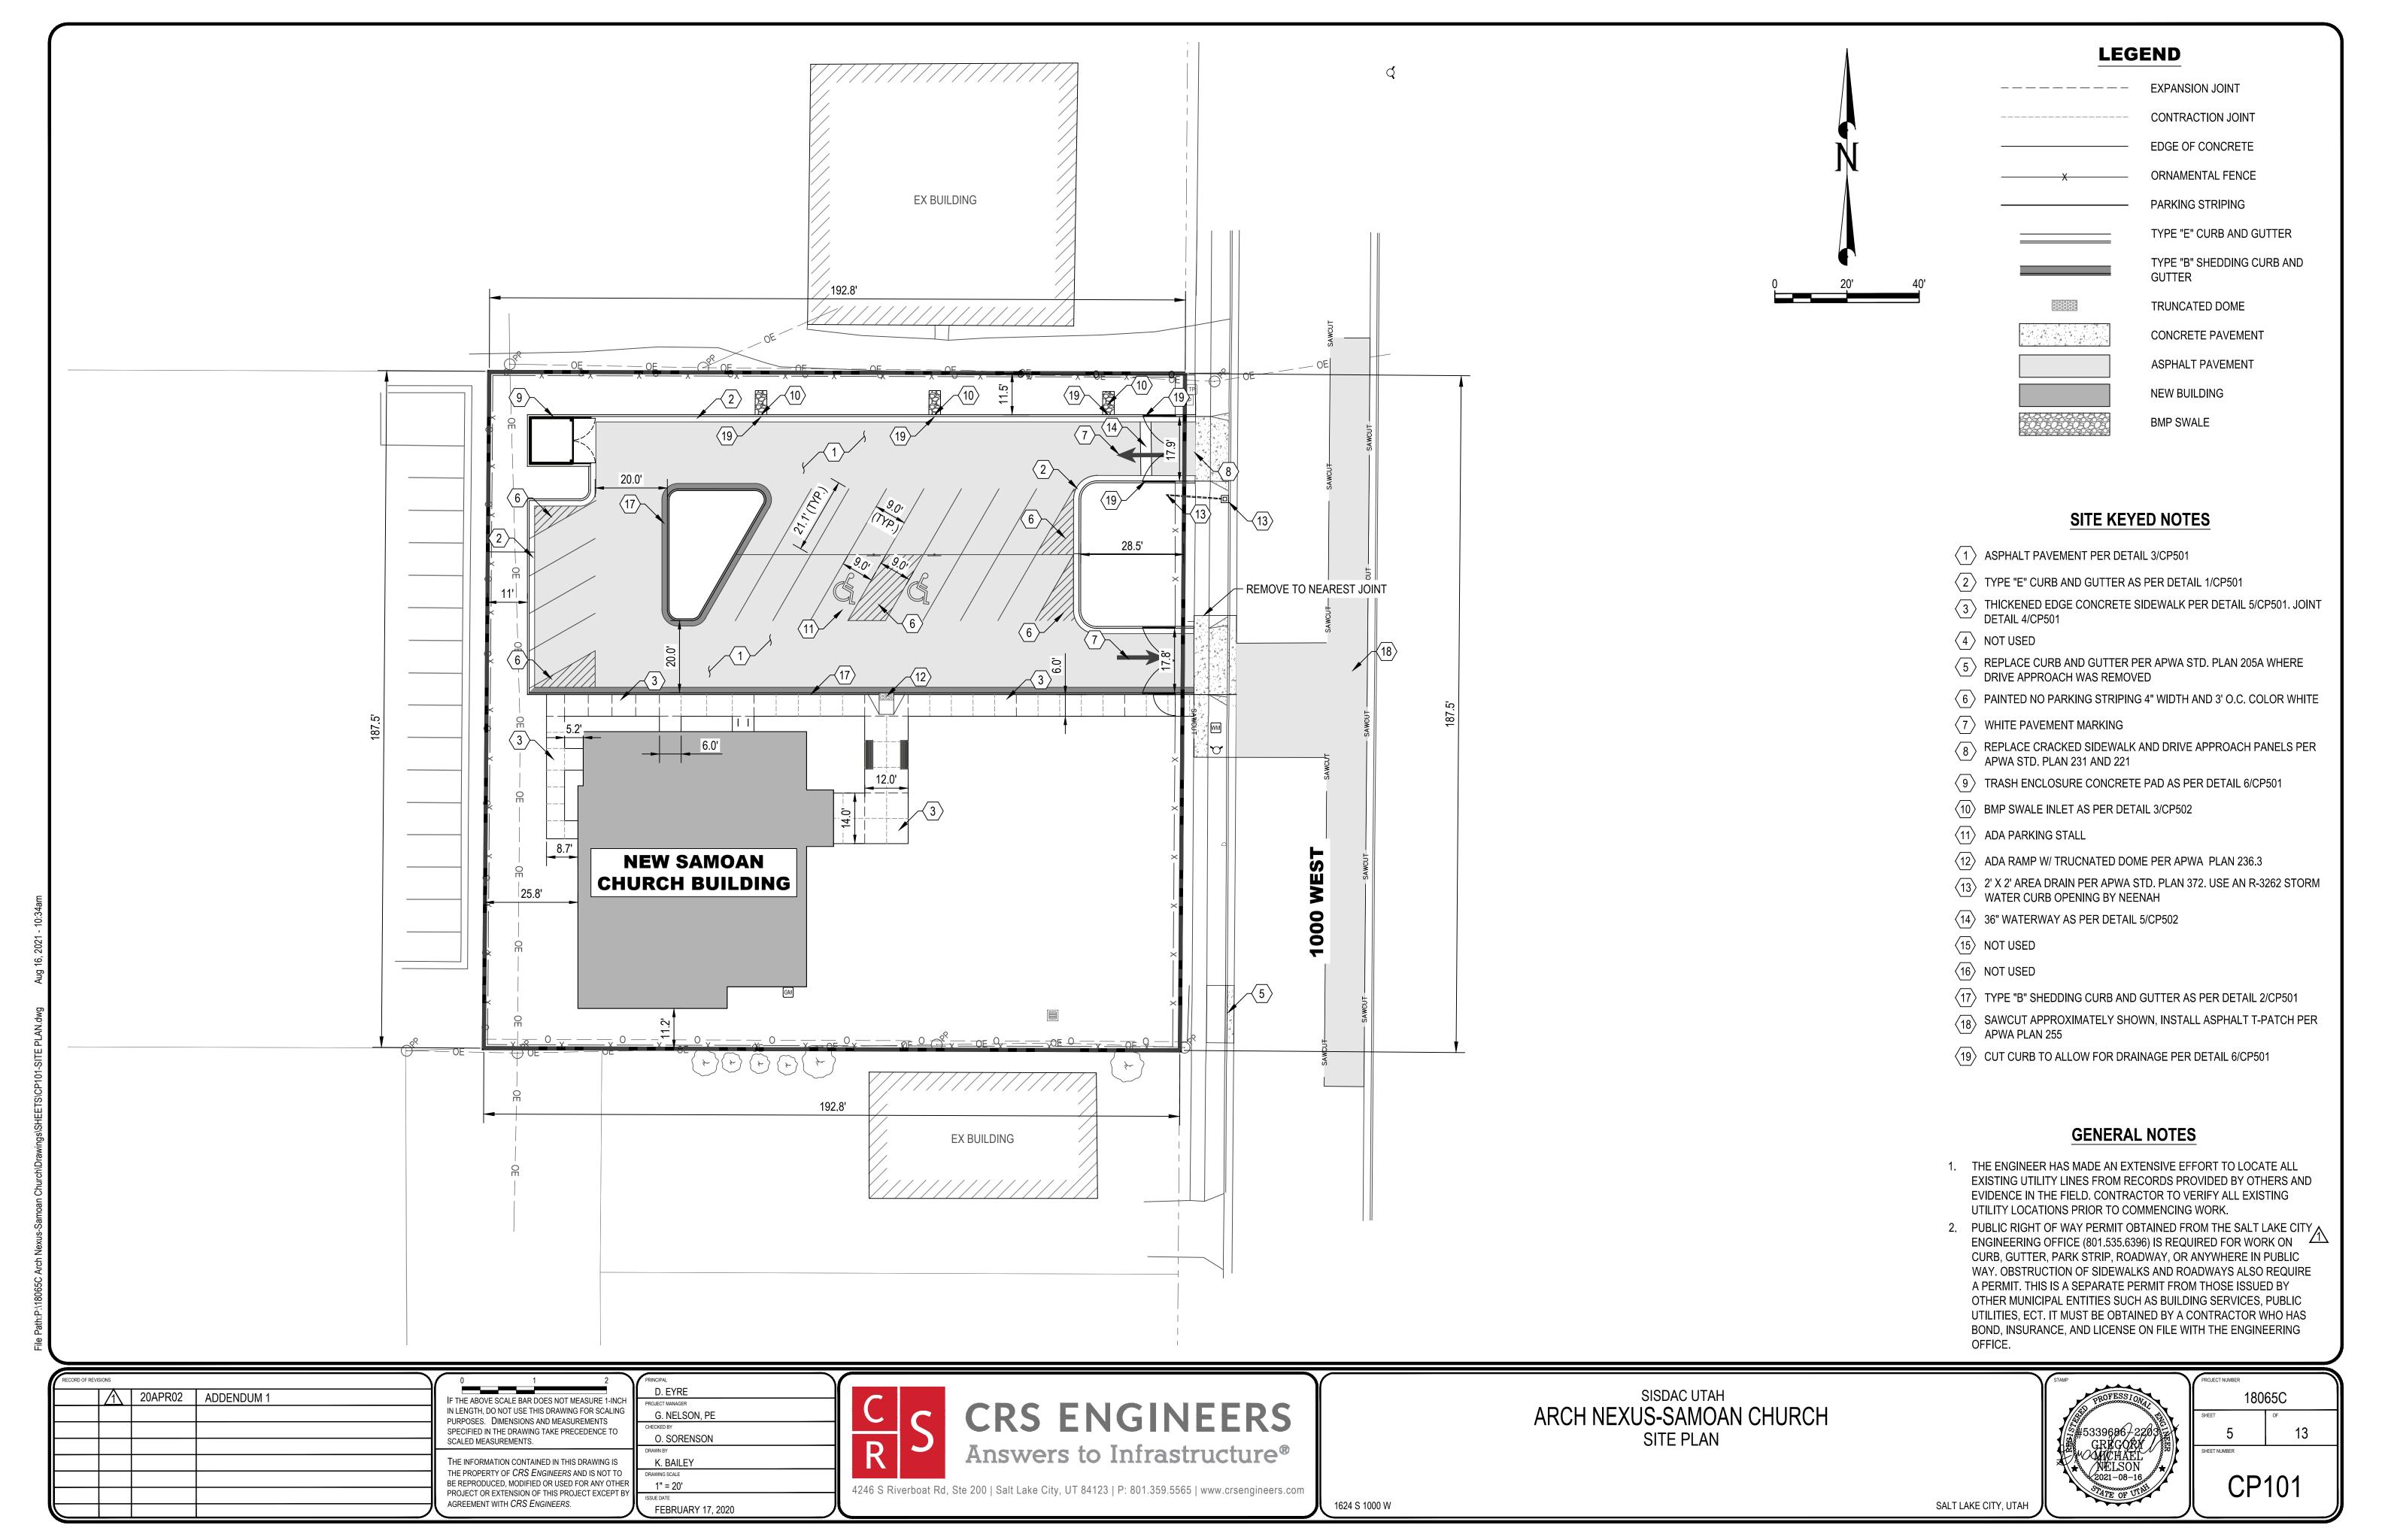

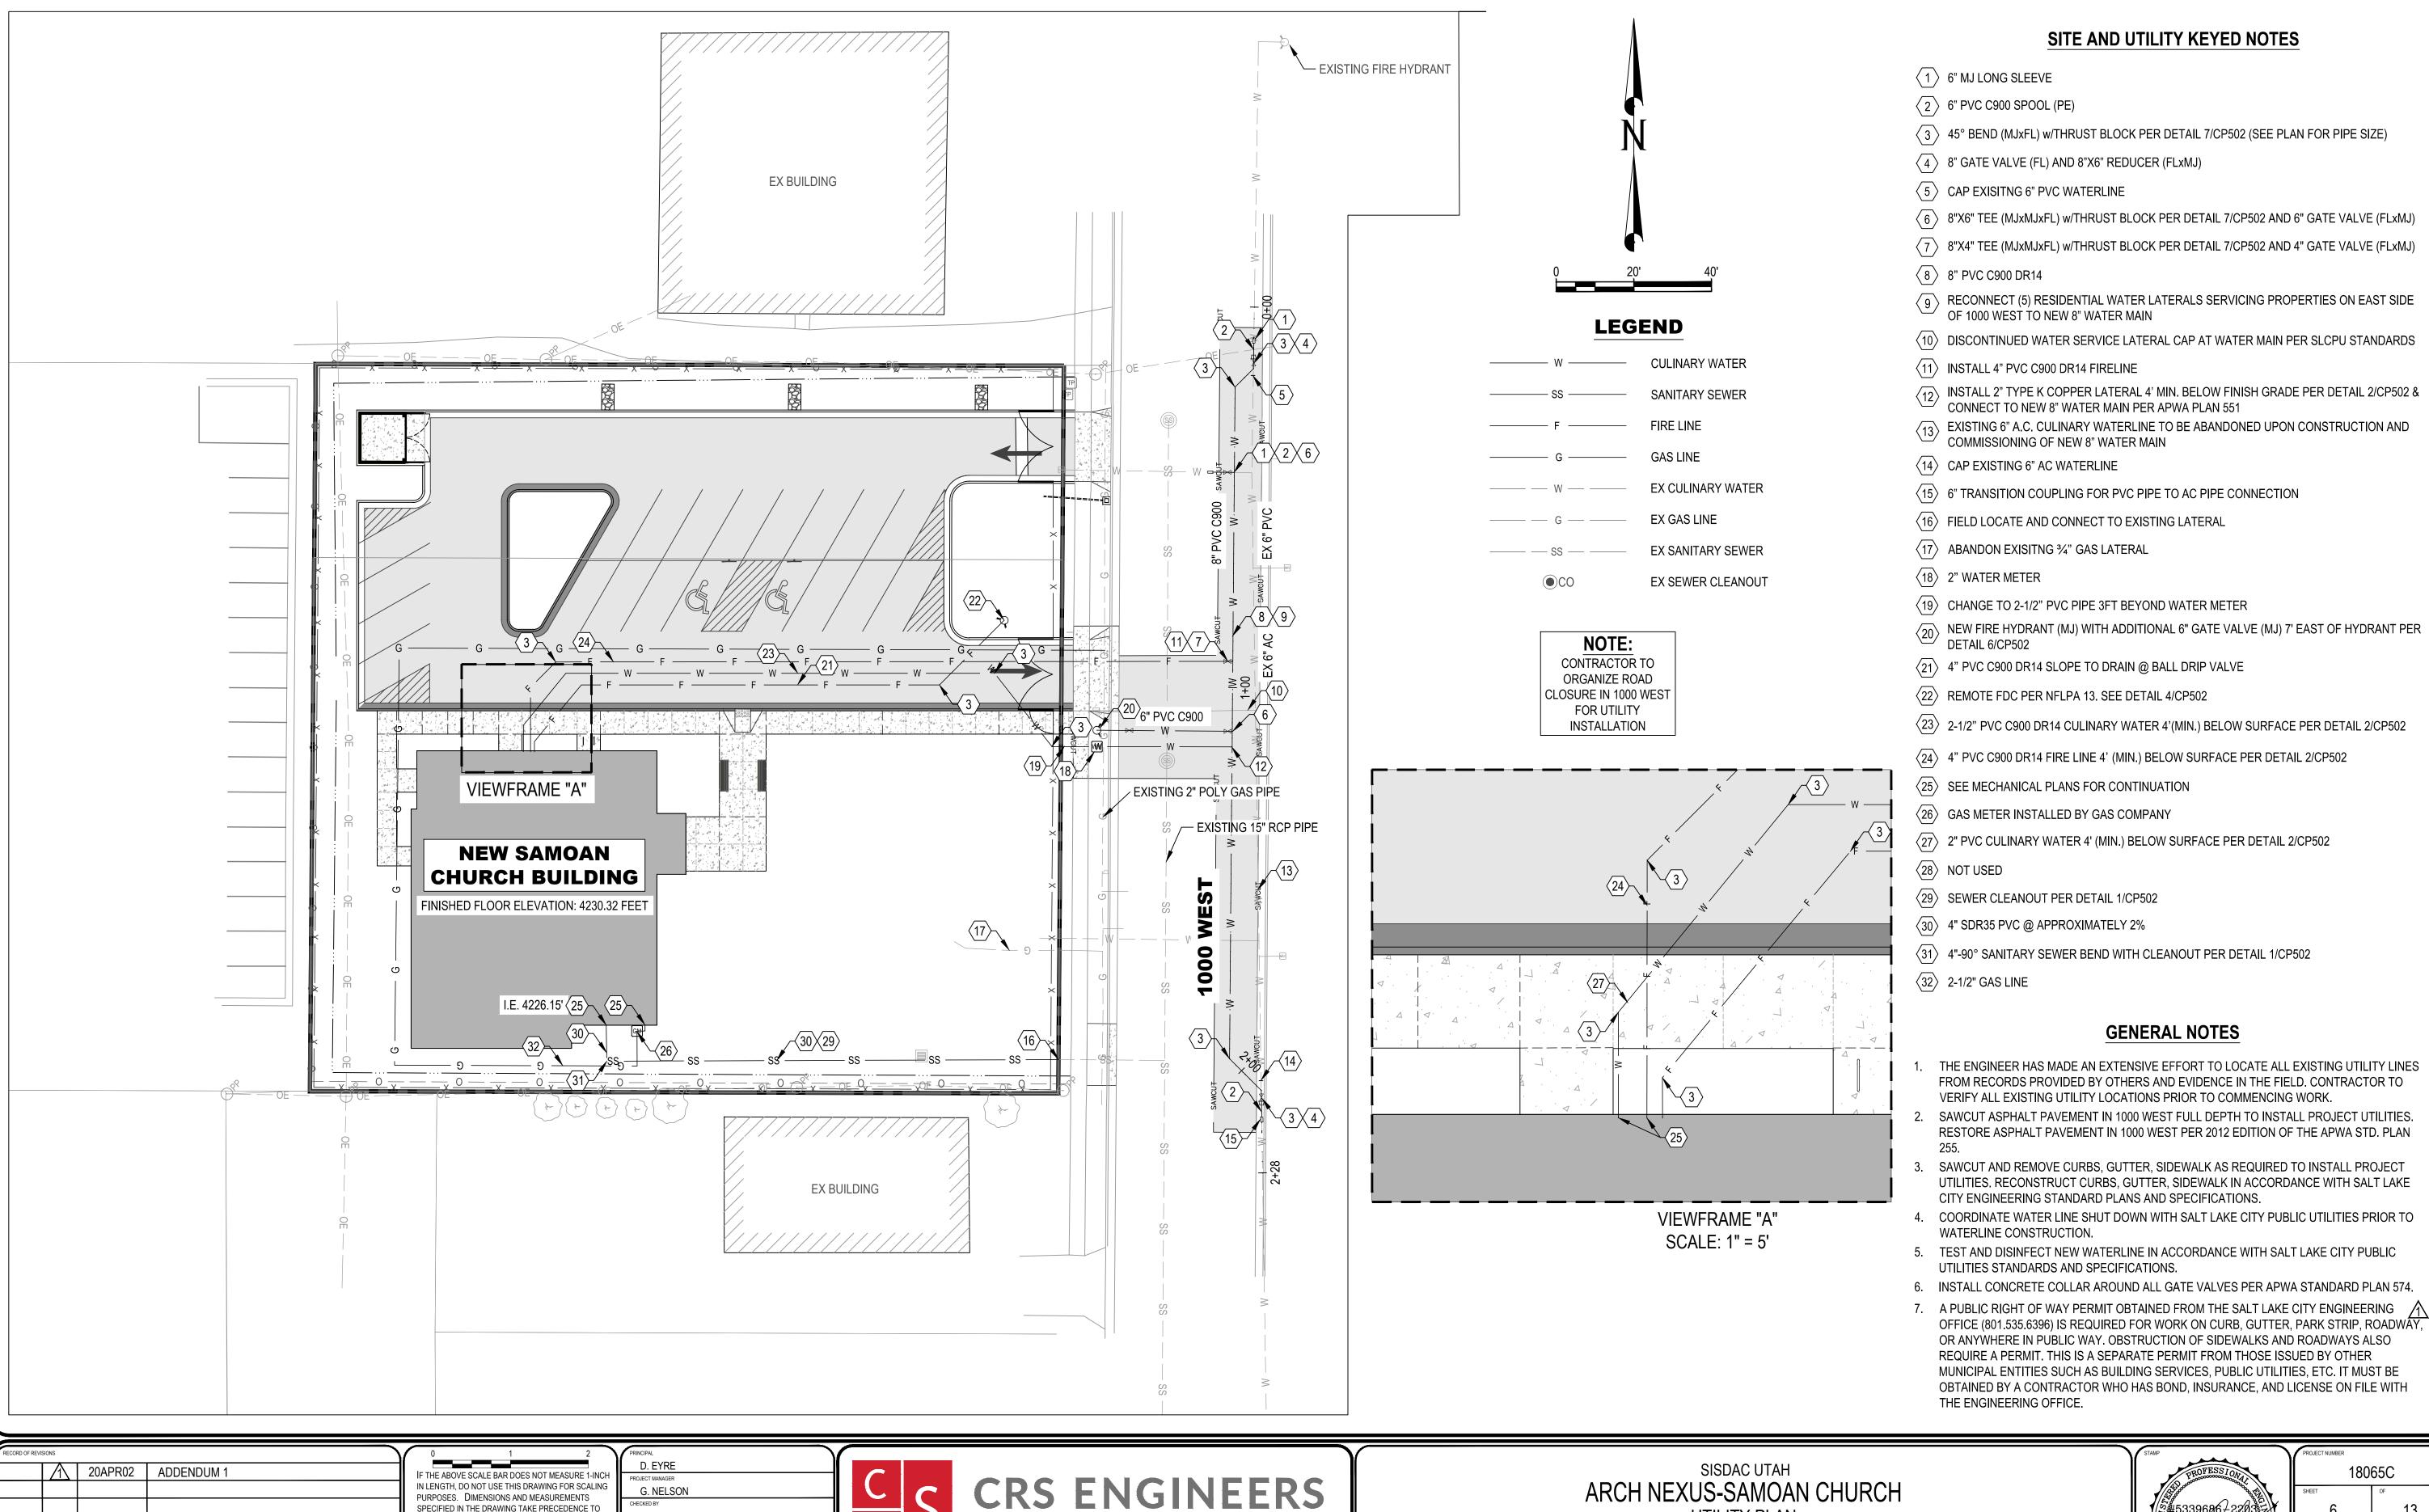

Answers to Infrastructure®

page 21

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G. NELSON

O. SORENSON

FEBRUARY 17, 2020

1" = 20'

PURPOSES. DIMENSIONS AND MEASUREMENTS SPECIFIED IN THE DRAWING TAKE PRECEDENCE TO

THE INFORMATION CONTAINED IN THIS DRAWING IS THE PROPERTY OF CRS ENGINEERS AND IS NOT TO

BE REPRODUCED, MODIFIED OR USED FOR ANY OTHER


PROJECT OR EXTENSION OF THIS PROJECT EXCEPT BY


AGREEMENT WITH CRS ENGINEERS.

SCALED MEASUREMENTS.


1624 S 1000 W

ARCH NEXUS-SAMOAN CHURCH UTILITY PLAN

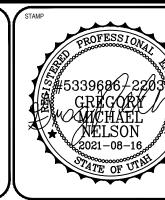

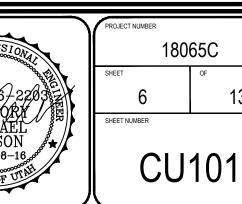

SALT LAKE CITY, UTAH

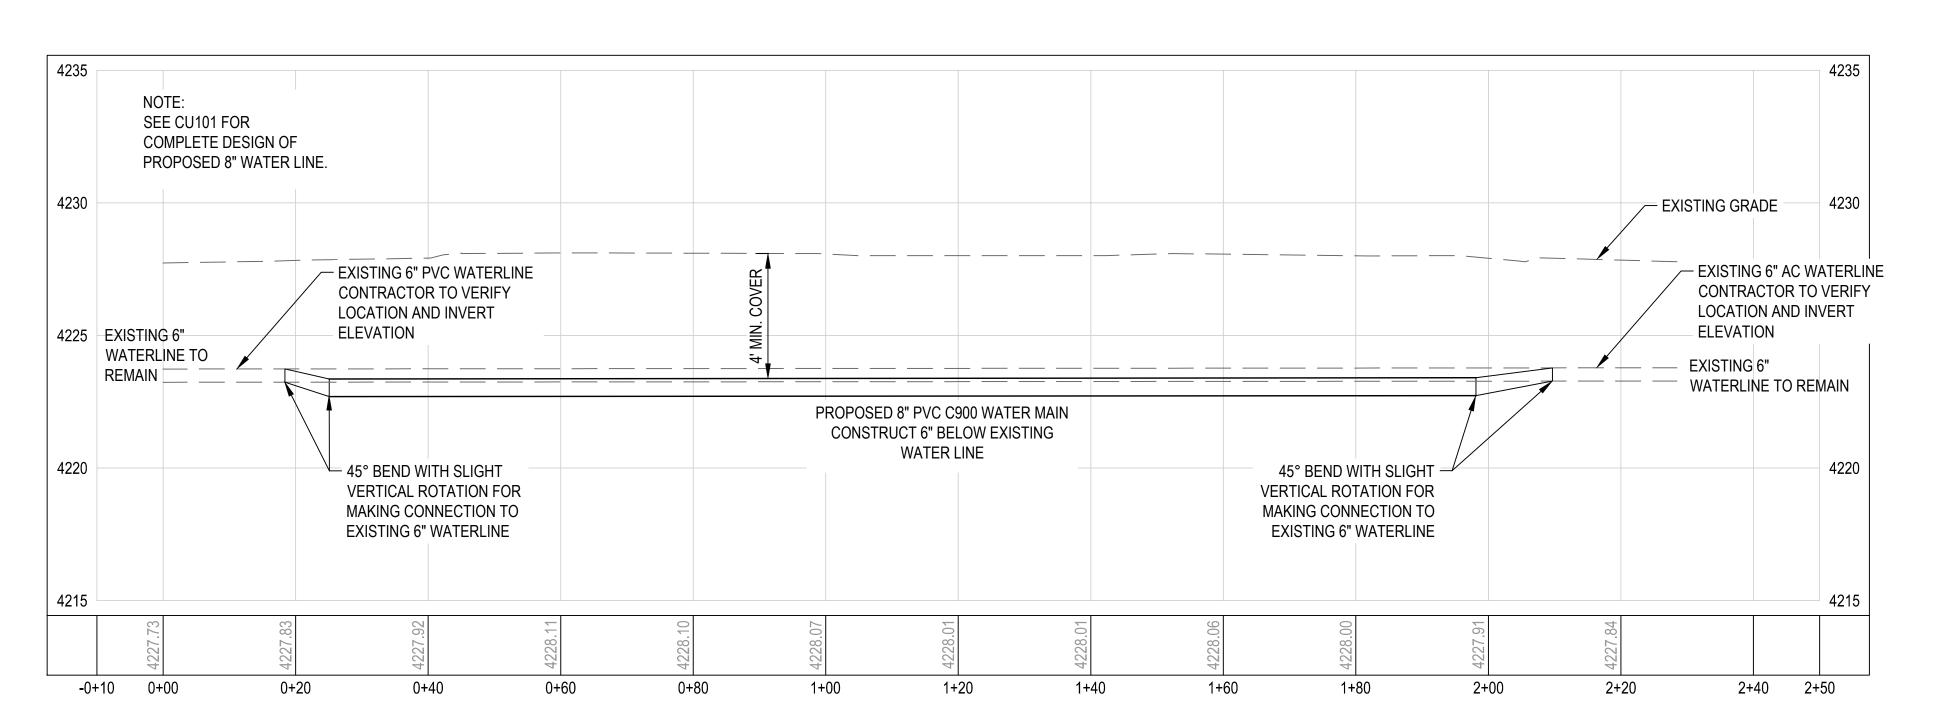

1 PROPOSED 8" PVC WATER MAIN CU301 SCALE: NONE

ECORD OF REVI	ISIONS		0 1 2
			IF THE ABOVE SCALE BAR DOES NOT MEASURE 1-INCH IN LENGTH, DO NOT USE THIS DRAWING FOR SCALING
			PURPOSES. DIMENSIONS AND MEASUREMENTS SPECIFIED IN THE DRAWING TAKE PRECEDENCE TO
			SCALED MEASUREMENTS.
	<u> </u>		THE INFORMATION CONTAINED IN THIS DRAWING IS THE PROPERTY OF CRS ENGINEERS AND IS NOT TO
	 '	<u> </u>	BE REPRODUCED, MODIFIED OR USED FOR ANY OTHER

AGREEMENT WITH CRS ENGINEERS.

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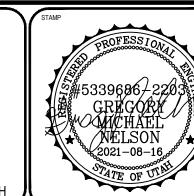
IF THE ABOVE SCALE BAR DOES NOT MEASURE 1-INCH IN LENGTH, DO NOT USE THIS DRAWING FOR SCALING PURPOSES. DIMENSIONS AND MEASUREMENTS SPECIFIED IN THE DRAWING TAKE PRECEDENCE TO SCALED MEASUREMENTS.

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FEBRUARY 17, 2020




SISDAC UTAH
ARCH NEXUS-SAMOAN CHURCH
WATERLINE PROFILE



7	PROJECT NUMBER	65C
	SHEET 7	OF 13
	SHEET NUMBER	
	CU:	301

1624 S 1000 W

SALT LAKE CITY, UTAH

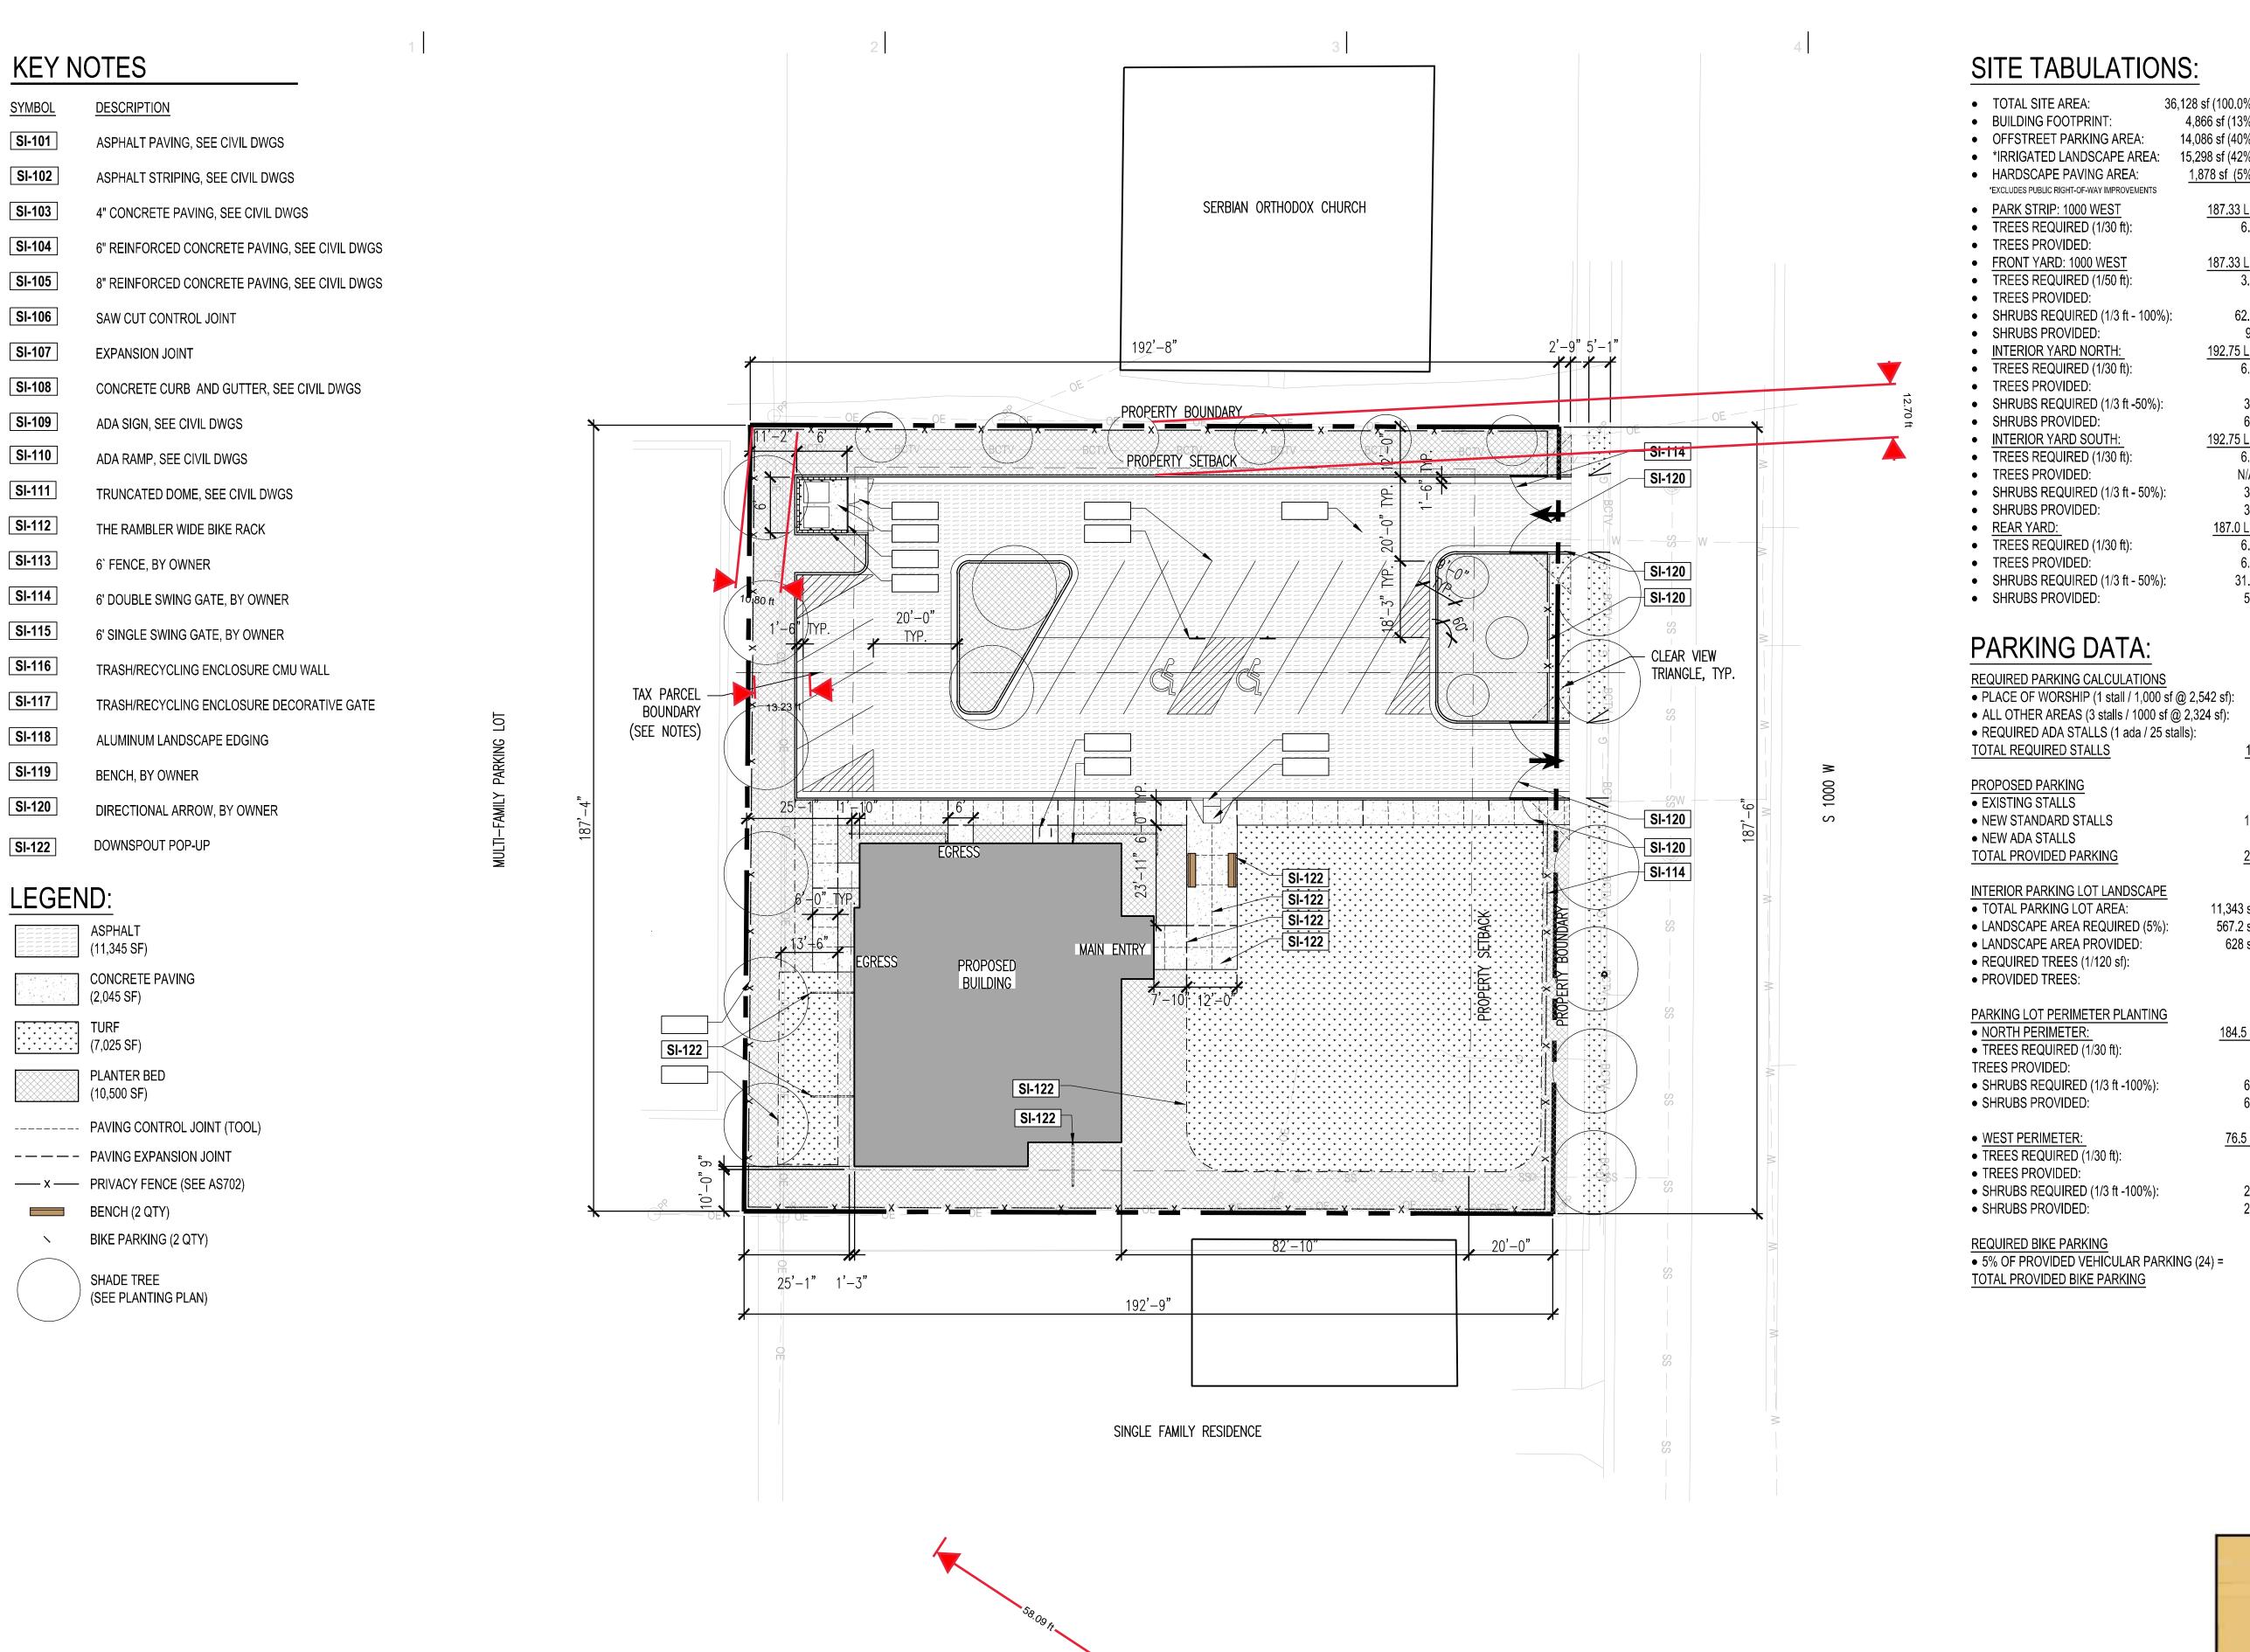

TE TABLU ATIONO

SITE TABULATION	<u>IS:</u>	G	iΕ
TOTAL SITE AREA: 36 BUILDING FOOTPRINT: OFFSTREET PARKING AREA: *IRRIGATED LANDSCAPE AREA: HARDSCAPE PAVING AREA: *EXCLUDES PUBLIC RIGHT-OF-WAY IMPROVEMENTS	5,128 sf (100.0%) 4,866 sf (13%) 14,086 sf (40%) 15,298 sf (42%) 1,878 sf (5%)	A.	T/ DI C/ 50 89 93
PARK STRIP: 1000 WEST TREES REQUIRED (1/30 ft): TREES PROVIDED: FRONT YARD: 1000 WEST TREES REQUIRED (1/50 ft): TREES PROVIDED: SHRUBS REQUIRED (1/3 ft - 100%):	187.33 LF 6.2 6 187.33 LF 3.7 9 62.3	B.	T/ D/ S/ 89 49 89
SHRUBS REQUIRED (1/3 It - 100%). SHRUBS PROVIDED: INTERIOR YARD NORTH: TREES REQUIRED (1/30 ft):	91 192.75 LF 6.4	C.	O L/
TREES PROVIDED: SHRUBS REQUIRED (1/3 ft -50%): SHRUBS PROVIDED:	6 32 67	D.	L/ LI W R
INTERIOR YARD SOUTH: TREES REQUIRED (1/30 ft): TREES PROVIDED: SHRUBS REQUIRED (1/3 ft - 50%): SHRUBS PROVIDED:	192.75 LF 6.4 N/A 32 33	E.	FI C' TI
REAR YARD: TREES REQUIRED (1/30 ft): TREES PROVIDED:	187.0 LF 6.2 6.0	F. G.	Di Pi Al
SHRUBS REQUIRED (1/3 ft - 50%): SHRUBS PROVIDED:	31.2 55	H.	C S
PARKING DATA:			C F(

ARKING DATA:		
QUIRED PARKING CALCULATIONS		
PLACE OF WORSHIP (1 stall / 1,000 sf @ 2	2,542 sf): 3].
ALL OTHER AREAS (3 stalls / 1000 sf @ 2,	324 sf): 7	l.
REQUIRED ADA STALLS (1 ada / 25 stalls)		
TAL REQUIRED STALLS	<u>11</u>	
ACROCED BARKING		
OPOSED PARKING	٥	
EXISTING STALLS	0	
NEW STANDARD STALLS NEW ADA STALLS	18 2	
NEW ADA STALLS OTAL PROVIDED PARKING	20	
TAL FROVIDED FARRING	<u>20</u>	
FERIOR PARKING LOT LANDSCAPE		
TOTAL PARKING LOT AREA:	11,343 sf	
LANDSCAPE AREA REQUIRED (5%):	567.2 sf	
LANDSCAPE AREA PROVIDED:	628 sf	
REQUIRED TREES (1/120 sf):	5	
PROVIDED TREES:	5	
RKING LOT PERIMETER PLANTING		
NORTH PERIMETER:	184.5 lf	
FREES REQUIRED (1/30 ft):	6	
EES PROVIDED:	6	
SHRUBS REQUIRED (1/3 ft -100%):	62	
SHRUBS PROVIDED:	67	Ü
WEST PERIMETER:	76.5 lf	
TREES REQUIRED (1/30 ft):	3	
FREES PROVIDED:	3	
SHRUBS REQUIRED (1/3 ft -100%):	26	
·		

CENIEDAL NOTES.

j	ENERAL NOTES:
	TAX PARCEL #15-14-252-013-0000. LEGAL
	DESCRIPTION: BEG E 12 RDS & N 455.395 FT FR SW
	COR OF NE 1/4 SEC 14, T 1S, R 1W, SLM; N 0^11'15" E
	50 FT; S 89^55'53" W 192.78 FT; S 0^11'15" W 50 FT; N
	89^55'53" E 192.78 FT TO BEG. 0.22 AC 7100-749
	9321-542 9875-6308
	TAX PARCEL #15-14-252-014-0000. LEGAL
	DESCRIPTION: BEG E 198 FT & N 317.695 FT FR CEN
	SEC 14, T 1S, R 1W, S L MN 0^11"15" E 137.7 FT; S
	89^55"53" W 192.78 FT; S 0^11'15" W137.7 FT M OR L; N
	89^55"53" E 192.78 FT TO BEG. 0.61 AC M OR L
	4917-0787 6469-1281 6592-1987 7100-0751 7452-2348
	8595-6349 9875-6308
	OFF-STREET PARKING IS TO COMPLY WITH SALT
	LAKE CITY ORDINANCE (21A.44.020) AND RELATED
	OF OTION O

SECTIONS.

LANDSCAPE REQUIREMENTS INCLUDING, BUT NOT LIMITED TO, LANDSCAPE BUFFERS ARE TO COMPLY WITH SALT LAKE CITY ORDINANCE (21A.48) AND RELATED SECTIONS. FIELD VERIFY ALL EXISTING CONDITIONS AND THEIR

COMPATIBILITY WITH NEW CONSTRUCTION PRIOR TO THE COMMENCEMENT OF WORK, COORDINATE DISCREPANCIES WITH ARCHITECT. DO NOT SCALE DRAWINGS.

PROVIDE ADA PARKING SIGN AT EACH DESIGNATED ADA PARKING STALL.

COORDINATE ALL UTILITY CROSSING INCLUDING; STORM DRAINS, WATER, AND GAS LINES. COORDINATE DEMO WORK AND SCHEDULING WITH CIVIL AND LANDSCAPING. PROVIDE BLOCK OUTS FOR UTILITY TO PASS THRU FOUNDATION WALLS. SEE TYPICAL DETAILS IN CIVIL, LANDSCAPE AND STRUCTURAL. THE CONTRACTOR IS RESPONSIBLE TO VERIFY THE

EXISTING SITE CONDITIONS AND THEIR COMPATIBILITY WITH NEW CONSTRUCTION PRIOR TO BEGINNING WORK AND TO BRING TO THE ATTENTION OF THE ARCHITECT ANY DISCREPANCIES OF STATED VERSUS ACTUAL SITE CONDITIONS. SHOULD DISCREPANCIES EXIST THE CONTRACTOR IS RESPONSIBLE FOR PROVIDING WRITTEN NOTICE OF SUCH DISCREPANCIES DELIVERED TO THE ARCHITECT ON CONTRACTOR COMPANY LETTERHEAD PRIOR TO BEGINNING WORK. IN THE EVENT THE CONTRACTOR FAILS TO VERIFY AND CONFIRM THE STATED VERSUS ACTUAL SITE CONDITIONS AND THEIR COMPATIBILITY WITH NEW CONSTRUCTION PRIOR TO BEGINNING WORK AND

DISCREPANCIES DO IN FACT EXIST, THE CONTRACTOR SHALL BE RESPONSIBLE FOR ANY AND ALL MODIFICATIONS TO CONSTRUCTION WORK AS DIRECTED BY THE ARCHITECT INCLUDING REPLACEMENT OF HARDSCAPE ITEMS, FIXTURES AND SITE IMPROVEMENTS AT NO ADDITIONAL COST TO THE OWNER.

J. SEE LANDSCAPE, ARCHITECTURAL, STRUCTURAL, MECHANICAL AND ELECTRICAL DRAWINGS FOR MORE INFORMATION.

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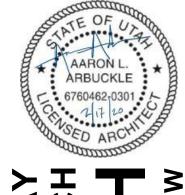
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Salt Lake City, UT 84109

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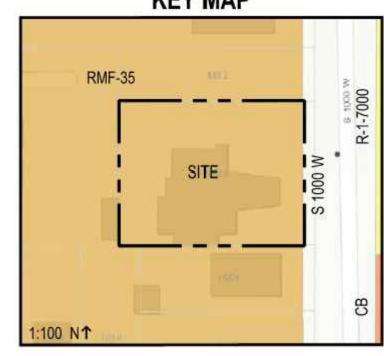


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Date Revision 1 05/03/21 City Comments

INDE


KEY MAP



CONSTRUCTION **DOCUMENTS**

NEXUS PROJECT #: 18030 CHECKED BY: CS DRAWN BY: TS 02.14.20 DATE:

SITE IMPROVEMENTS **PLAN**

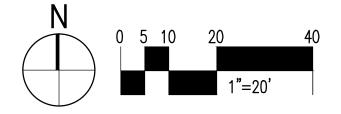

SYMBOL	DESCRIPTION	<u>QTY</u>	<u>DETAIL</u>
SI-101	ASPHALT PAVING	11,345 sf	(SEE CIVIL)
SI-102	ASPHALT STRIPING COLOR: WHITE	NA	A4, B4 AS701
SI-103	4" CONCRETE PAVING MEDIUM BROOM FINISH, STANDARD GRAY COLOR	2,045 sf	(SEE CIVIL)
SI-104	6" REINFORCED CONCRETE PAVING MEDIUM BROOM FINISH, STANDARD GRAY COLOR	160 sf	(SEE CIVIL)
SI-105	8" REINFORCED CONCRETE PAVING MEDIUM BROOM FINISH, STANDARD GRAY COLOR	66.5 sf	(SEE CIVIL)
SI-106	SAW CUT CONTROL JOINT	NA	A5 AS701
SI-107	EXPANSION JOINT	NA	B5 AS701
SI-108	CONCRETE CURB AND GUTTER MEDIUM BROOM FINISH, STANDARD GRAY COLOR	NA	(SEE CIVIL)
SI-109	ADA SIGN, AS APPROVED	2	C4 AS701
SI-110	ADA RAMP	2	C5 AS701
SI-111	TRUNCATED DOME STRONGGO INDUSTRIES, TEKWAY DOME PAVER	1	D5 AS701
SI-112	THE RAMBLER WIDE BIKE RACK TYPE: 5/8" x 2 ½" STEEL FLAT BAR, SIZE: 16"w x 36"h, EMBED MOUNT, COLOR: MATTE BLACK BK-08	2	C1, D1 AS702
SI-113	6` FENCE AMERISTAR MONTAGE II GENESIS LINE, 3 RAIL PANEL, PERMACOAT FINISH, COLOR: BLACK,	711 lf	C4 AS702
SI-114	6` DOUBLE SWING GATE AMERISTAR MONTAGE II GATE, GENESIS LINE, 3 RAIL, PERMACOAT FINISH, COLOR: BLACK	2	A1, A2 AS702
SI-115	6` SINGLE SWING GATE AMERISTAR MONTAGE II GATE, GENESIS LINE, 3 RAIL, PERMACOAT FINISH, COLOR: BLACK	1	C2 AS702
SI-116	TRASH/RECYCLING ENCLOSURE CMU WALL STRUCTURAL MASONRY STYLE	1	A1, B2, D2 AS
SI-117	TRASH/RECYCLING ENCLOSURE SOLID STEEL GATE PRIMER: SHERWIN WILLIAMS PRO INDUSTRIAL PROCRYL UNIVERSAL PRIMER, FINISH: SHERWIN WILLIAMS SHER-CRY SAFETY BLACK	1	A1, B2, D2 AS
SI-118	ALUMINUM LANDSCAPE EDGING PERMALOC, CLEANLINE, MILL FINISH, 1/8"x4", INSTALL PER MANUFACTURER`S SPECIFICATIONS	365 If	D3 AS701
SI-119	LANDSCAPE FORMS PAL-72-S, BY OWNER PALISADE 72 SURFACE MOUNT, BACKLESS BENCH	3	A2 AS701
SI-120	DIRECTIONAL ARROW, BY OWNER COLOR: WHITE	2	SEE PLAN

SI-122

page 24

DOWNSPOUT POP-UP


NDS 4 IN. PLASTIC POP-UP DRAINAGE EMITTER WITH 4" COREX DRAIN PIPE PERFORATED WITH SOCK



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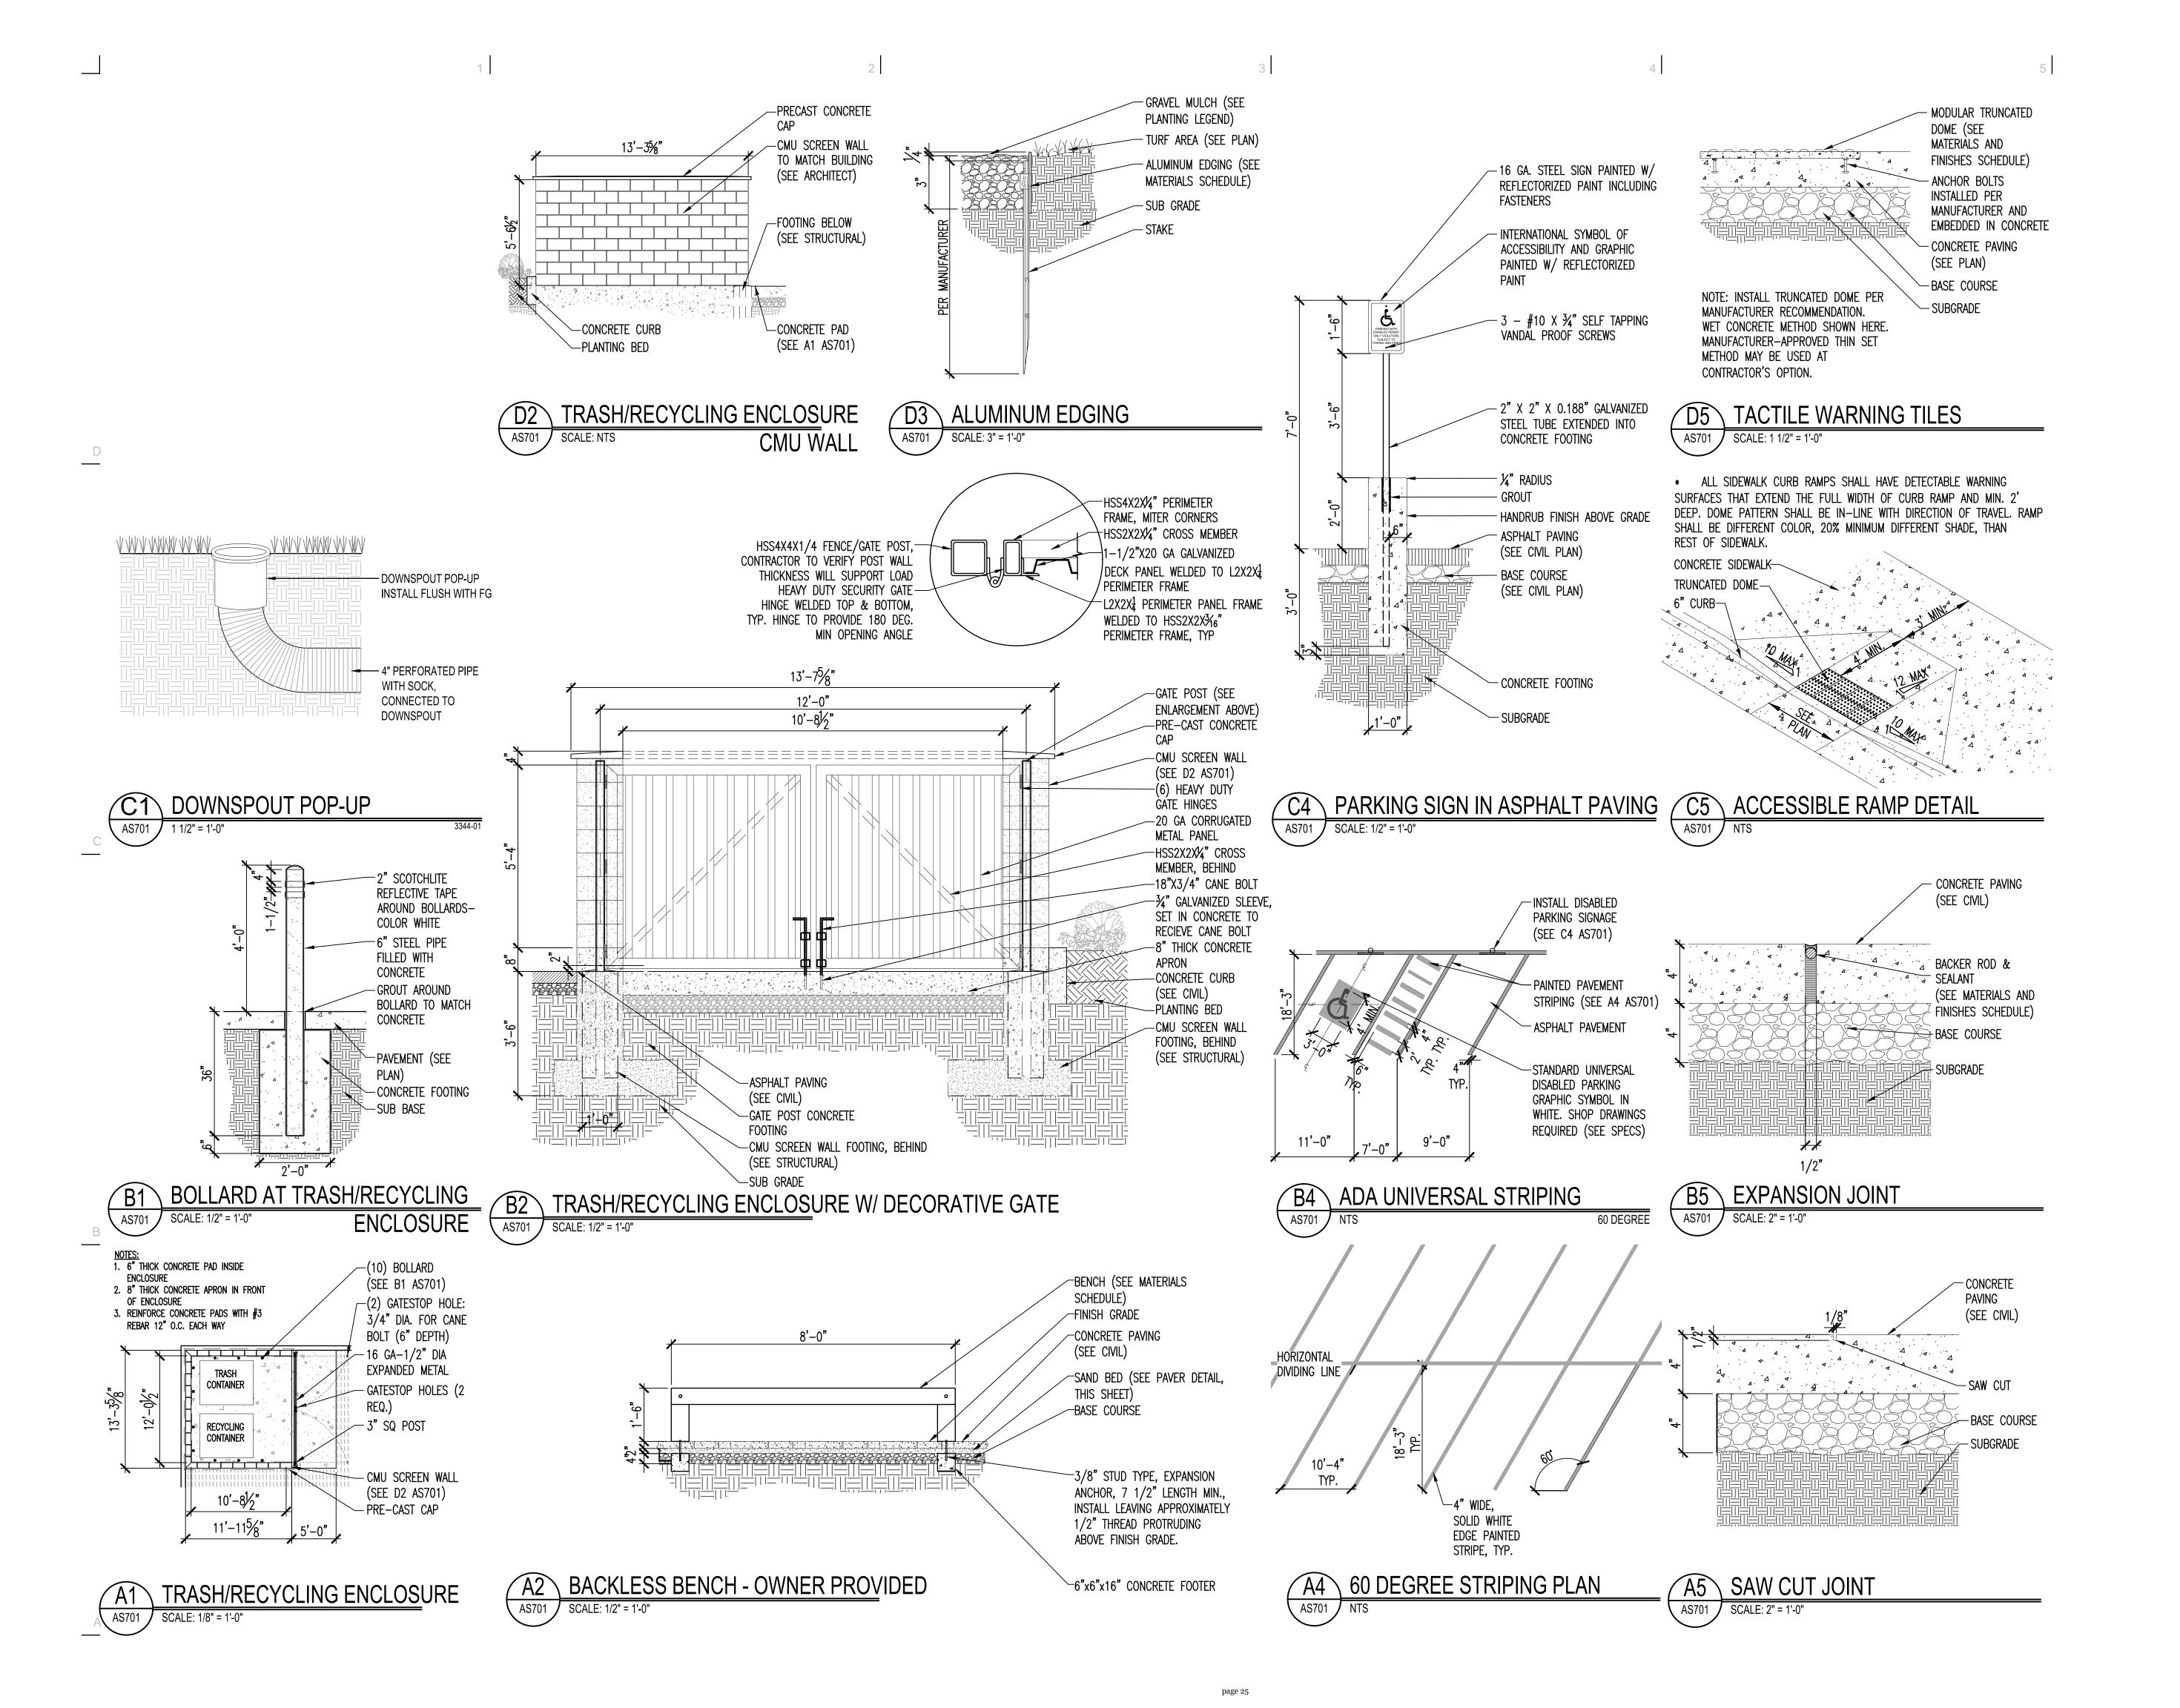
Date Revision

CONSTRUCTION DOCUMENTS

NEXUS PROJECT #: 18030 CHECKED BY: CS DRAWN BY: TS DATE: 02.14.20

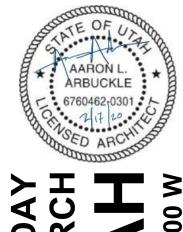SITE IMPROVEMENT **MATERIALS AND** FINISHES SCHEDULE

AS601






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INDE S

Date POST BID ADDENDUM A

2 04.01.2019

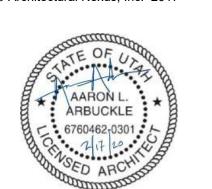CCD #01


CONSTRUCTION **DOCUMENTS**

NEXUS PROJECT #: 18030 CHECKED BY: CS **DRAWN BY:**

02.14.20 DATE: SITE IMPROVEMENT

DETAILS

AS701

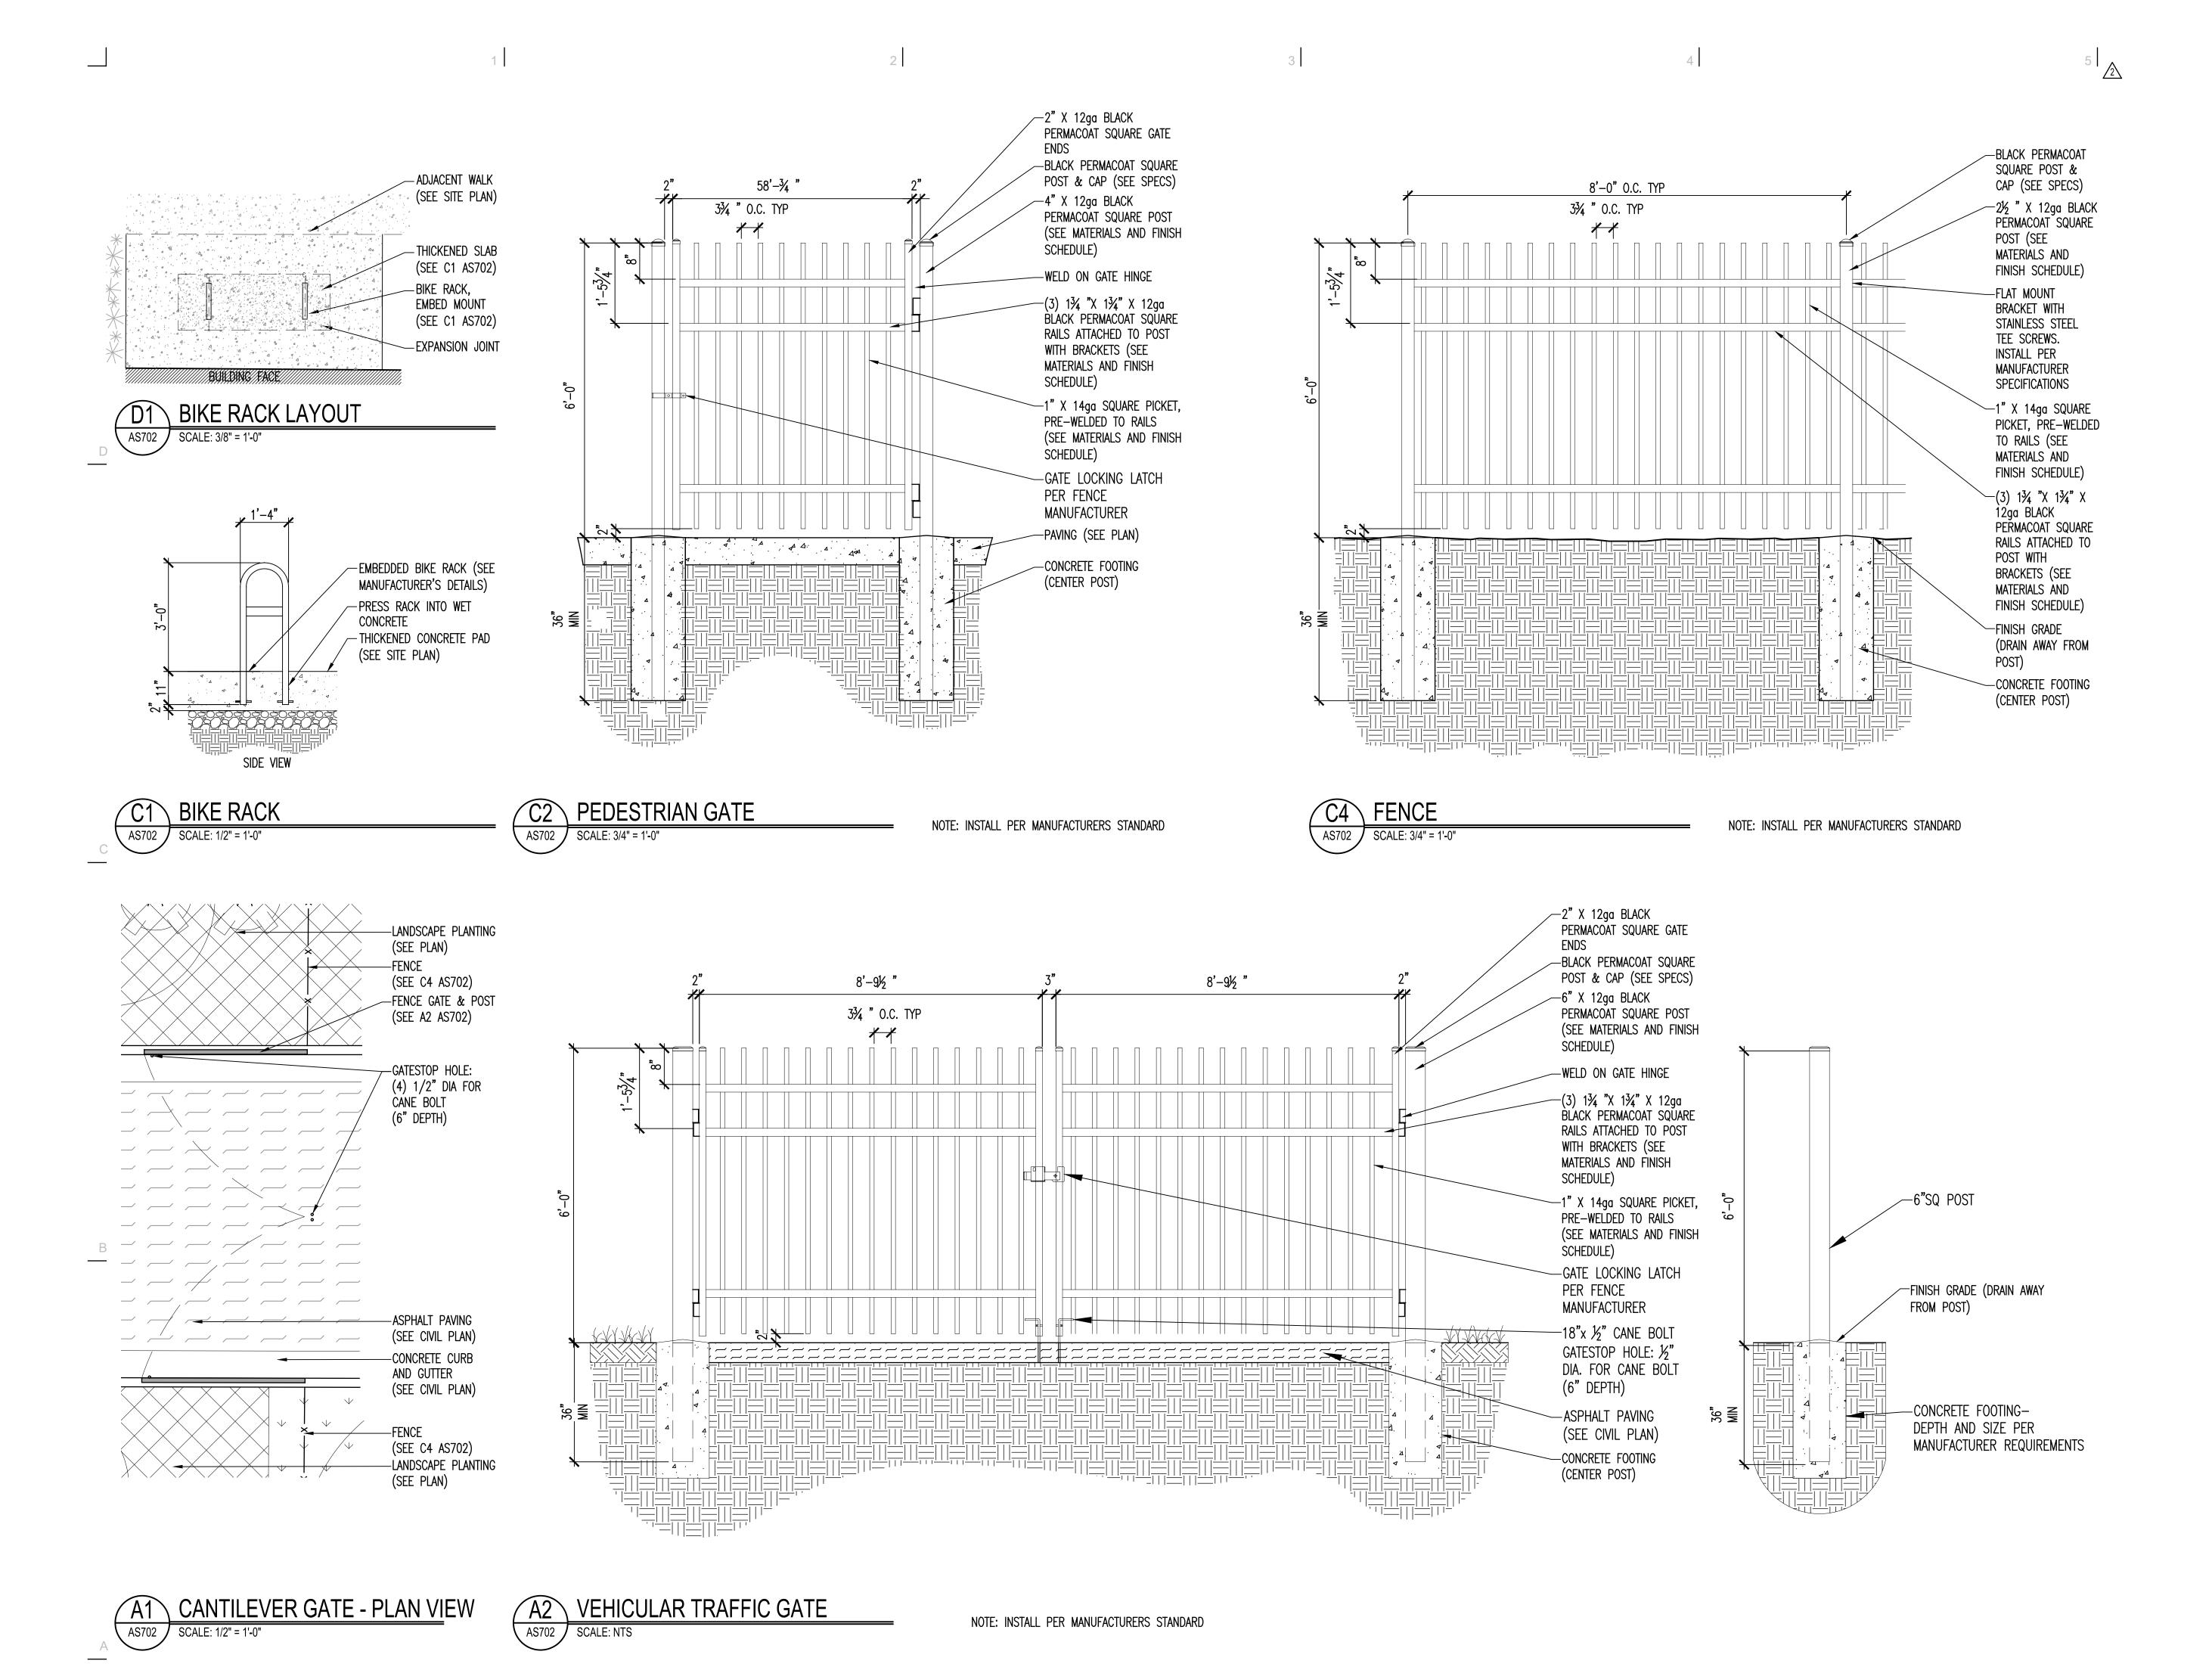




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Date

CONSTRUCTION DOCUMENTS

NEXUS PROJECT #: 18030 CHECKED BY: CS DRAWN BY:

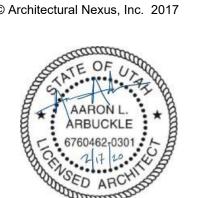02.14.20 SITE IMPROVEMENT **DETAILS**

AS702

PLANTING PLAN GENDERAL NOTES:

- 1. THE CONTRACTOR IS RESPONSIBLE FOR COMPARING THE EXISTING SITE CONDITIONS WITH THE PLANTING PLAN PRIOR TO BEGINNING WORK AND IMMEDIATELY NOTIFYING THE ARCHITECT IN WRITING OF ANY DISCREPANCIES BETWEEN ACTUAL SITE CONDITIONS AND THE PLANTING PLAN. IN THE EVENT THE CONTRACTOR FAILS TO COMPARE EXISTING SITE CONDITIONS WITH THE PLANTING PLANS PRIOR TO BEGINNING WORK AND/OR FAILS TO NOTIFY THE ARCHITECT OF ANY DISCREPANCIES IN WRITING PRIOR TO BEGINNING WORK, THE CONTRACTOR SHALL ASSUME FULL RESPONSIBILITY FOR ANY REQUIRED ALTERATIONS AND ADDITIONS TO THE PLANTING PLAN, INCLUDING ADDITIONAL MATERIALS AT NO ADDITIONAL COST TO THE OWNER.
- 2. CONTRACTOR SHALL COORDINATE PLANT PLACEMENT WITH IRRIGATION SYSTEM.
- 3. CONTRACTOR SHALL IMMEDIATELY REPAIR ANY DAMAGES CAUSED BY CONSTRUCTION OPERATIONS, ON OR OFF OF THE SITE, WITH NO ADDITIONAL COSTS TO THE OWNER.
- 4. REFER TO PLANTING LEGEND, DETAILS AND SPECIFICATIONS FOR MORE INFORMATION.




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ADVENTIST CHURCH Salt Lake City, UT 84104

CONSTRUCTION
O 5 10 20 40 DOCUMENTS

NEXUS PROJECT #: 18030 CHECKED BY: CS DRAWN BY: TS DATE: 02.14.20

Date

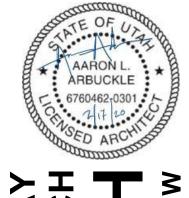PLANTING PLAN

1"=20'

NEXUS PROCHECKED DRAWN BY

PLANTING SCHEDULE

<u>TREES</u> MATURE SIZE (HXW) QTY <u>CODE</u> BOTANICAL NAME CONTAINER SIZE COMMON NAME 2" CAL. ACE TAT ACER TATARICUM 25**`**X20**`** TATARIAN MAPLE 6 2" CAL. 20'X20' CER CAN CERCIS CANADENSIS EASTERN REDBUD 3 2" CAL. 25**`**X20**`** KOE MUL KOELREUTERIA PANICULATA GOLDENRAIN TREE 6 PRU KWA PRUNUS SERRULATA 'KWANZAN' 2" CAL. 25**`**X20**`** FLOWERING CHERRY THU SMA THUJA OCCIDENTALIS 'SMARAGD' 15**`**X4**`** EMERALD GREEN ARBORVITAE 5'-6' 12 50'X40' 2" CAL. ZELKOVA SERRATA 'GREEN VASE' GREEN VASE ZELKOVA MATURE SIZE (HXW) QTY <u>SHRUBS</u> <u>CODE</u> **BOTANICAL NAME** COMMON NAME CONTAINER SIZE 2'X2' SUNJOY MINI SALSA BARBERRY BERBERIS THUNBERGII 'MIMI' TM 16 #5 LIG LOD LIGUSTRUM VULGARE 'LODENSE' LODENSE PRIVET 4'X4' 42 #5 4'X4' PEROVSKIA ATRIPLICIFOLIA RUSSIAN SAGE 46 BUCKLEY'S QUILL MOCKORANGE 5 GAL. PHILADELPHUS X 'BUCKLEY'S QUILL' 6'X4' 38 6'X6' PHYSOCARPUS OPULIFOLIUS 'SUMMER WINE' 5 GAL. 27 SUMMER WINE NINEBARK ABBOTSWOOD POTENTILLA 3'X3' 5 GAL. POT ABB POTENTILLA FRUTICOSA 'ABBOTSWOOD' 30 ROSA MEIDILAND SERIES 'FIRE' FIRE MEIDILAND ROSE 5 GAL. 2'X4' 20 MATURE SIZE (HXW) QTY <u>CODE</u> <u>PERENNIALS</u> **BOTANICAL NAME** CONTAINER SIZE COMMON NAME YUC FIL YUCCA FILAMENTOSA ADAM'S NEEDLE 3 GAL. 3'X3' 29 YUCCA FILAMENTOSA 'BRIGHT EDGE' 3'X3' ADAM'S NEEDLE 3 GAL. YUC COL YUCCA FILAMENTOSA 'COLOR GUARD' 3 GAL. ADAM'S NEEDLE 3'X3' 30

COMMON NAME

BLUE OAT GRASS

COMMON NAME

BLUEGRASS

1,900 sf C4 LP701

ADAGIO MAIDEN GRASS

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SAMOAN

MATURE SIZE (HXW) QTY

50

49

1,543 SF

36"X24"

CONTAINER SIZE MATURE SIZE (HXW) QTY

3'X3'

CONTAINER SIZE

1 GAL.

SOD

Date Revision

CONSTRUCTION **DOCUMENTS**

CS TS

NEXUS PROJECT #: 18030 CHECKED BY: DRAWN BY: 02.14.20 DATE:

PLANTING

LEGEND

LP601

MATERIALS

<u>GRASSES</u>

SOD/SEED

ψ ψ ψ ψ

<u>CODE</u>

MIS SIN

POA PRA

<u>CODE</u>

BOTANICAL NAME

BOTANICAL NAME

HELICTOTRICHON SEMPERVIRENS 'BLUE OATS'

MISCANTHUS SINENSIS 'ADAGIO'

BIONATIVE FROM BIOGRASS, OR EQUAL

<u>YMBOL</u>	DESCRIPTION	QTY	<u>DETAIL</u>
	CALICO COBBLE ROCK MULCH STAKER PARSONS, 1"-2" IN SIZE, MULTI-COLORED DECORATIVE ROCK (LOCATED @ BUILDING APRON)	15 cy	C4 LP701
********* ****** ****** *****	BARK MULCH, STAKER PARSONS, COLOR: BLACK	60 cy	C2 LP701

WEED BARRIER FABRIC, DeWITT, 6'x250',COLOR: BLACK, 5 oz. WOVEN, NEEDLE-PUNCHED

POLYPROPYLENE FABRIC, APPLICATION FOR PLANTING BEDS WITH CALICO COBBLE

GENERAL NOTE - FLOOR PLAN

- A. PLAN WALL DIMENSIONS ARE TO GRID LINE OR FACE OF WALL STRUCTURE. "CLEAR"
 DIMENSIONS ARE TO FACE OF WALL FINISH.
- B. FIELD VERIFY ALL EXISTING CONDITIONS AND THEIR COMPATIBILITY WITH NEW CONSTRUCTION PRIOR TO THE COMMENCEMENT OF WORK.

 COORDINATE DISCREPANCIES WITH ARCHITECT.
- C. DO NOT SCALE DRAWINGS.

 D. SEE CIVIL, STRUCTURAL, MECHANICAL AND
- ELECTRICAL DRAWINGS FOR MORE INFORMATION.

 E. SEE G SERIES SHEETS FOR WALL TYPES AND
 TYPICAL ACCESSIBILITY CLEARANCE AND
 COMPLIANCE REQUIREMENTS.
- F. PROVIDE BACKING BEHIND ALL SURFACE MOUNTED EQUIPMENT AND/OR FIXTURES
- G. LOCATE ALL DOORS PER MINIMUM CLEARANCES.
 4" CLEAR BETWEEN WALL AND DOOR FRAME,
 HINGE SIDE. UNLESS OTHERWISE NOTED. 12"
 CLEAR PUSH SIDE 18" CLEAR PULL SIDE ON LATCH
 SIDE OF DOOR.



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ALT LAKE CITY, UT 84104


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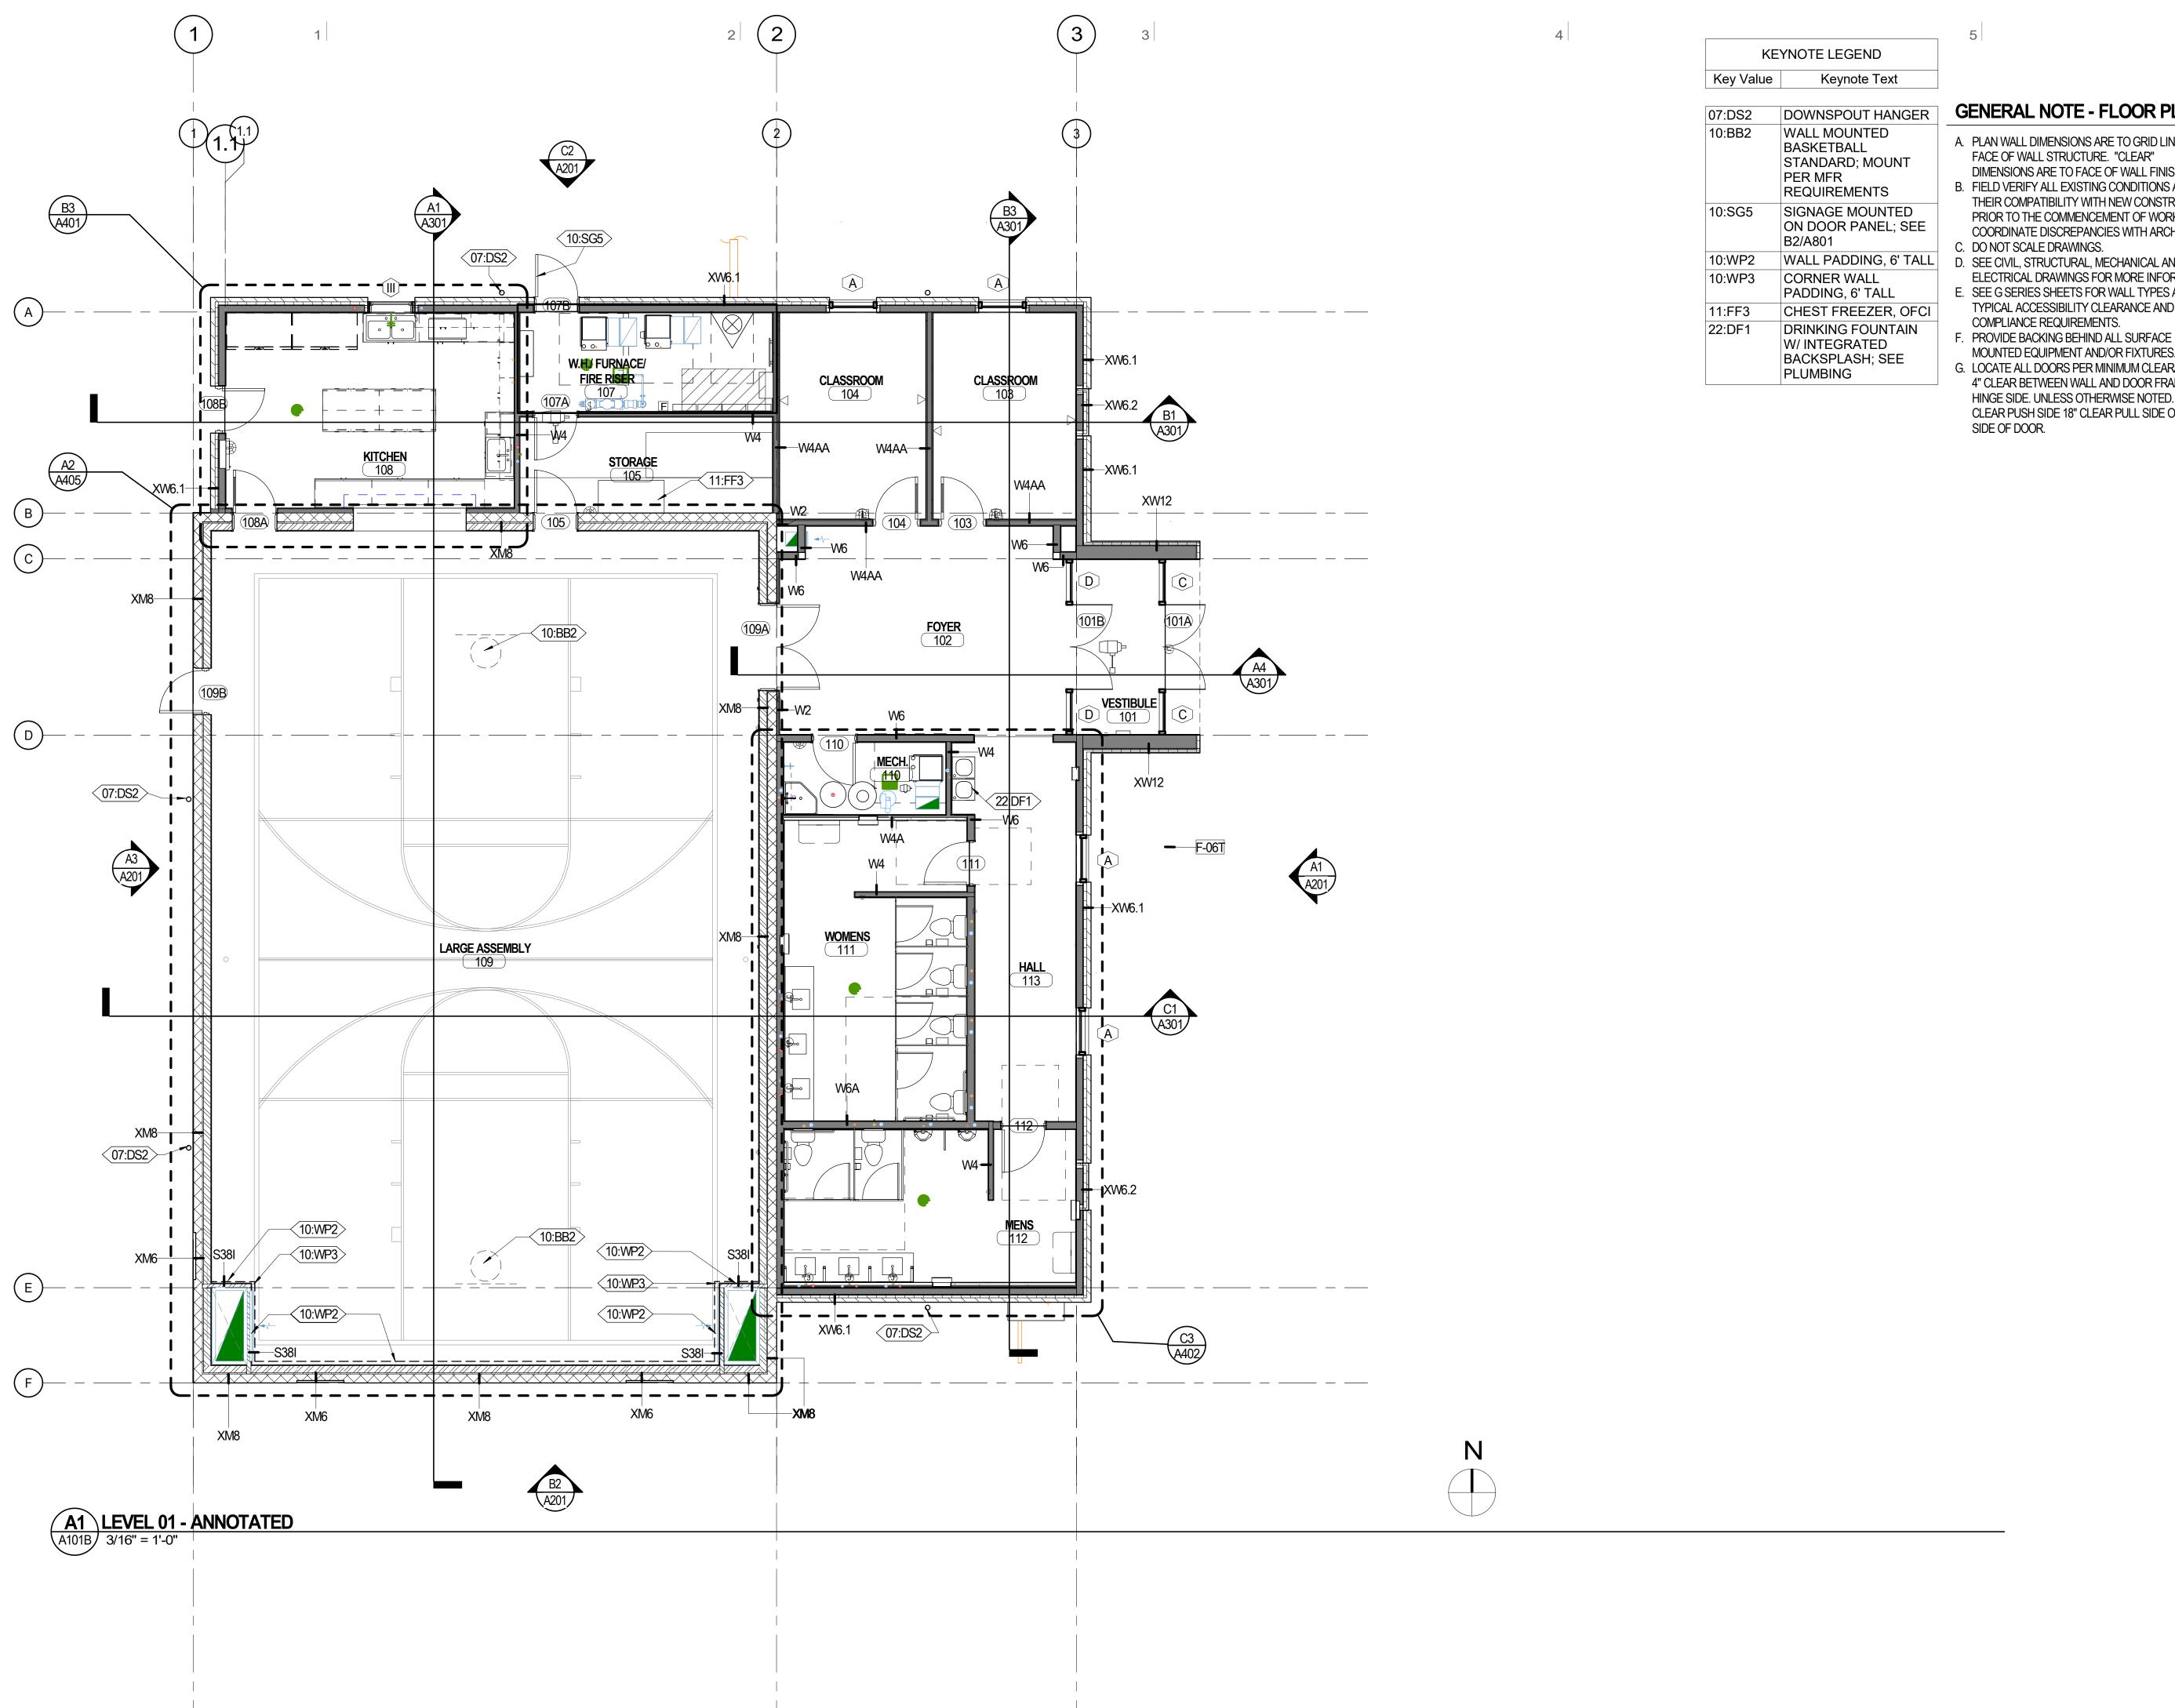
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NEXUS PROJECT #: 18030.1 CHECKED BY: Checker DRAWN BY: GEM DATE: 02/17/20

FLOOR PLAN-LEVEL 01 -DIMENSIONED

A101A



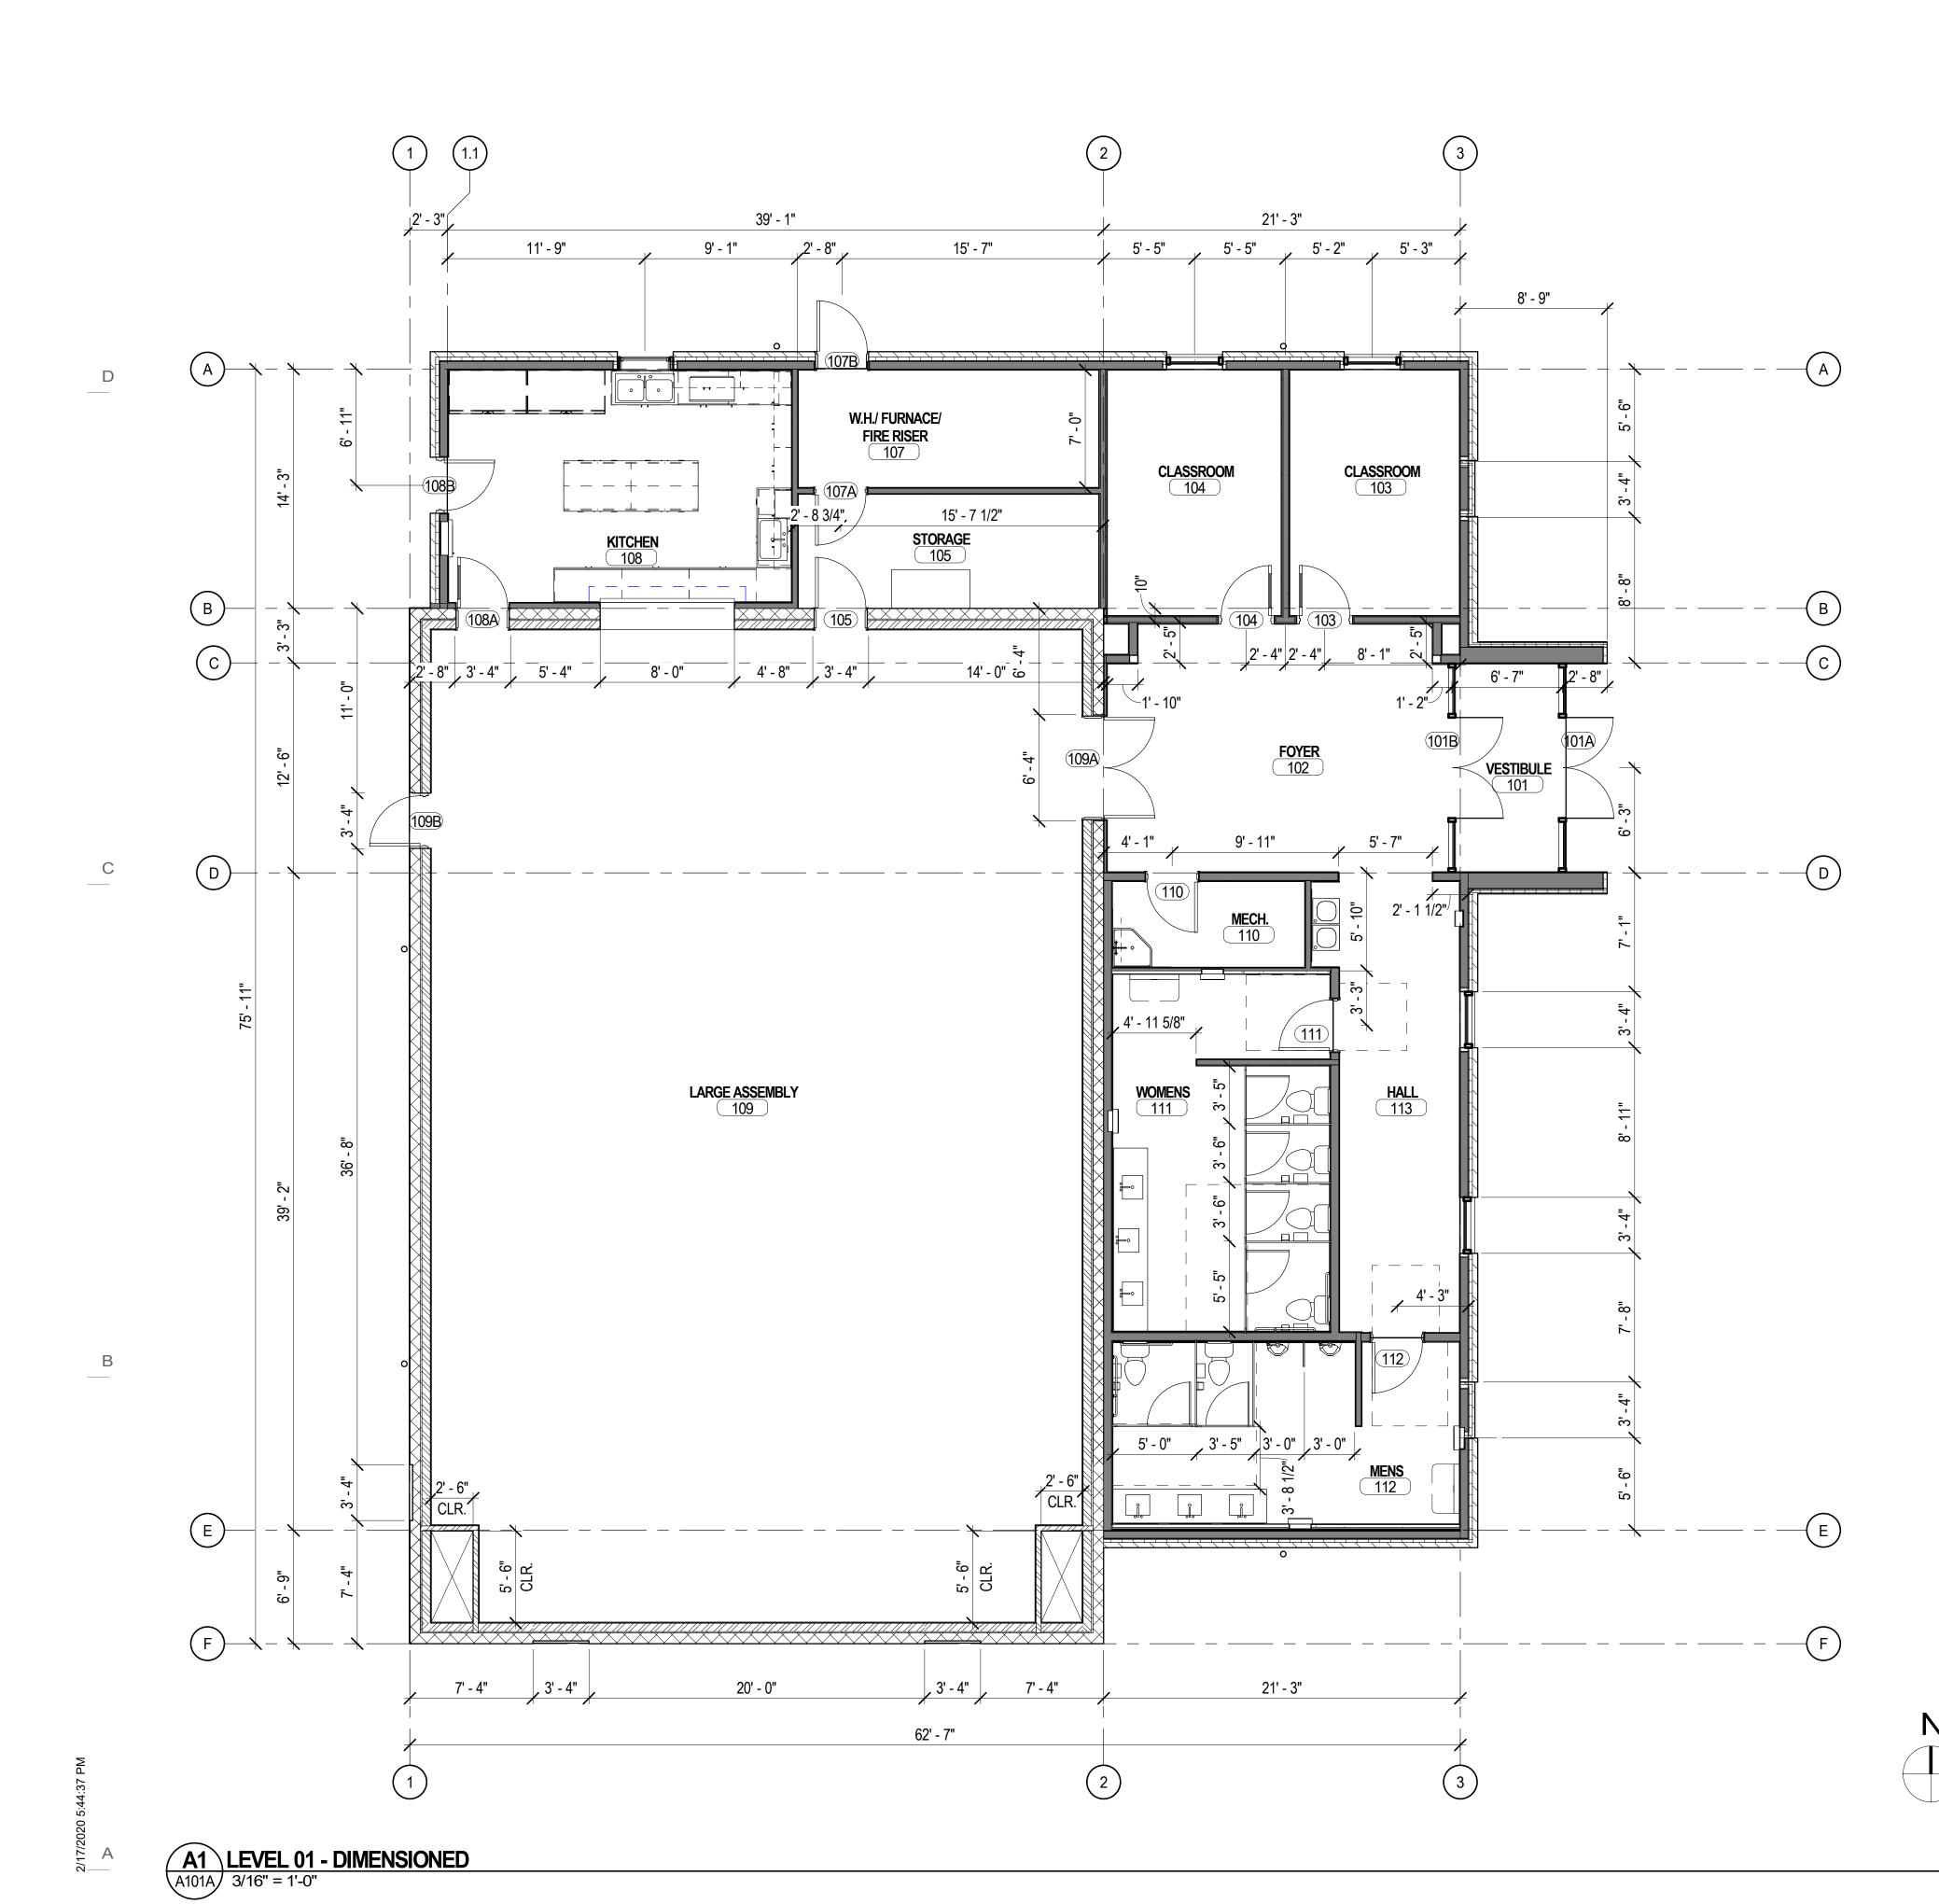

GENERAL NOTE - FLOOR PLAN A. PLAN WALL DIMENSIONS ARE TO GRID LINE OR

FACE OF WALL STRUCTURE. "CLEAR" DIMENSIONS ARE TO FACE OF WALL FINISH. B. FIELD VERIFY ALL EXISTING CONDITIONS AND THEIR COMPATIBILITY WITH NEW CONSTRUCTION

PRIOR TO THE COMMENCEMENT OF WORK. COORDINATE DISCREPANCIES WITH ARCHITECT. C. DO NOT SCALE DRAWINGS. D. SEE CIVIL, STRUCTURAL, MECHANICAL AND

ELECTRICAL DRAWINGS FOR MORE INFORMATION. E. SEE G SERIES SHEETS FOR WALL TYPES AND TYPICAL ACCESSIBILITY CLEARANCE AND COMPLIANCE REQUIREMENTS.

MOUNTED EQUIPMENT AND/OR FIXTURES. G. LOCATE ALL DOORS PER MINIMUM CLEARANCES. 4" CLEAR BETWEEN WALL AND DOOR FRAME, HINGE SIDE. UNLESS OTHERWISE NOTED. 12" CLEAR PUSH SIDE 18" CLEAR PULL SIDE ON LATCH SIDE OF DOOR.



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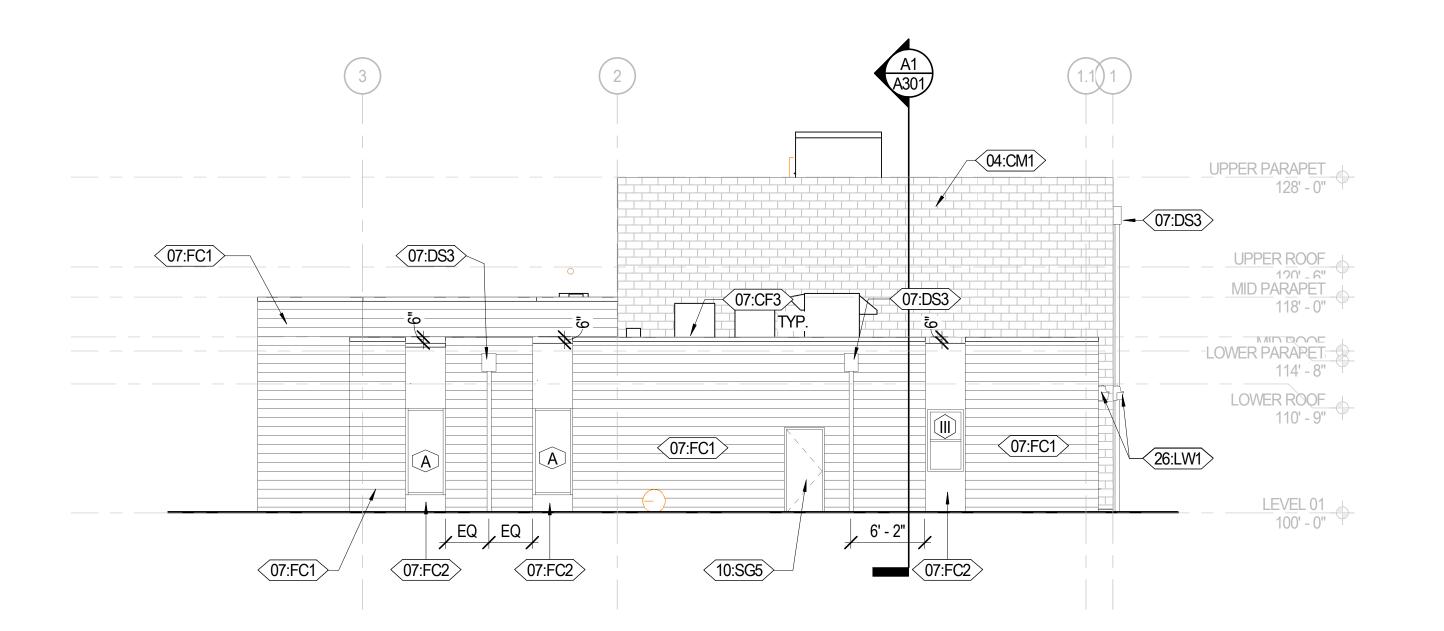
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FLOOR PLAN -**LEVEL 01 -ANNOTATED**

A101B



C2 NORTH ELEVATION A201 1/8" = 1'-0" 07:CF3 UPPER PARAPET 128' - 0" (07:DS3) **-**07:CF3 UPPER ROOF 1201 - 6" MID PARAPET 07:DS3 118' - 0" (04:CM1) LOWER PARAPET 114' - 8" __11' - 7"___ LOWER ROOF 07:FC1 07:DS3 11:ME1 LEVEL 01 100' - 0" 04:EJ1 **B2 SOUTH ELEVATION** A201 1/8" = 1'-0"

GENERAL NOTE -BUILDING ELEVATION

- A. COORDINATE GRADING SHOWN ON ELEVATIONS w/ CIVIL
- B. PROVIDE GUTTERS AND DOWN SPOUTS w/ HEAT CABLE, SNOW FENCES, AND SNOW CLIPS - SEE ROOF PLAN
- C. FOR TYPICAL WALL ASSEMBLY INCLUDING MATERIAL DESIGNATIONS AND DETAILING APPROACH, SEE A350 SERIES

Variable Tark				
Key Value Keynote Text				
04:CM1	CONCRETE MASONRY UNIT, STYLE 1. SEE STRUCTURAL FOR SIZE			
04:EJ1 MASONRY EXPANSION JOINT; TYP ALL WINDOWS IN MASONRY WALLS				
07:CF3	PRE-FINISHED PARAPET CAP FLASHING			
07:DS3	THRU-WALL SCUPPER WITH PRE-FINISHED CONDUCTOR, HEAD AND DOWNSPOUT. COLOR TO MATCH PAINT COLOR FOR SIDING.			
07:FC1	FIBER CEMENT BOARD LAP SIDING; PAINTED.			
07:FC2	FIBER CEMENT PANEL; PAINTED.SEE SPECIFICATIONS FOR COLOR			
10:SG5	SIGNAGE MOUNTED ON DOOR PANEL; SEE B2/A801			
11:LR1	ROOF TOP LADDER PAINTED TO MATCH EXTERIOR SIDING			
11:ME1	MECH. EQUIPMENT, SEE MECH.			
22:HB1	2:HB1 HOSE BIBB. SEE PLUMBING			
26:LW1	WALL MOUNTED LIGHT FIXTURE; SEE ELECTRICAL			



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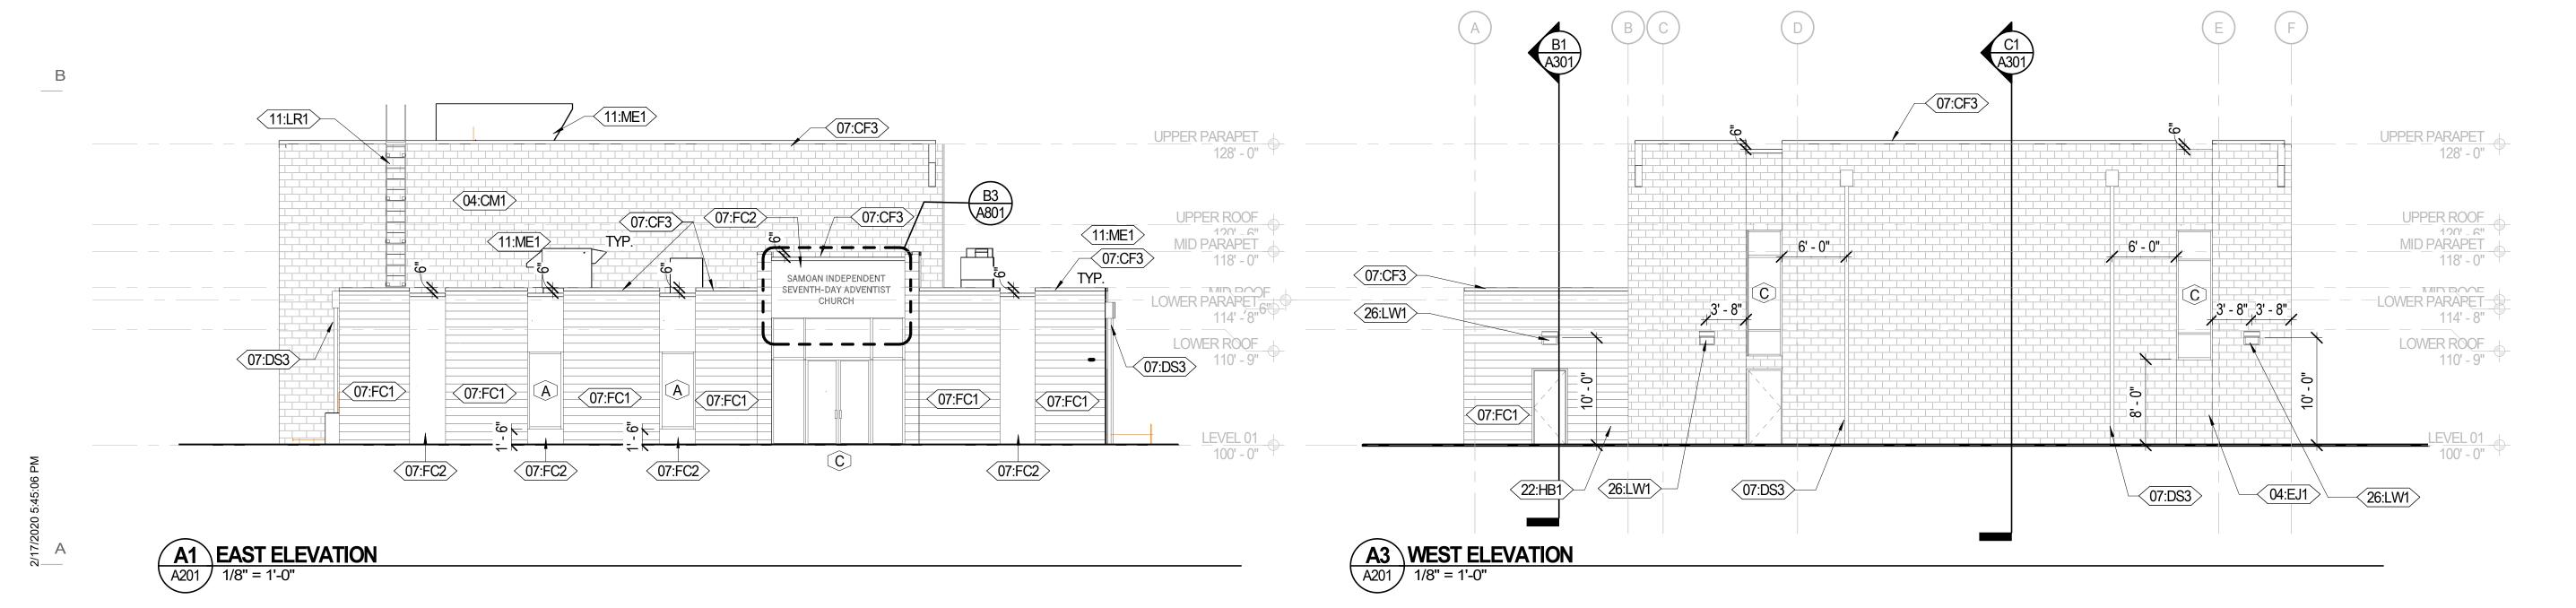
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BUILDING ELEVATIONS

A201



2

3


1. SIGN FIGURES AND TEXT TO BE DARK BRONZE METAL FINISH 2. FIGURES AND TEXT TO BE MOUNTED ON A STAINLESS STEEL PLATE. PLATE TO BE MOUNTED TO WALL WITH HIDDEN FASTENERS. 3. MOUNT ON WALL AT LATCH SIDE OF DOOR WITHIN 18" OF OPENING AND AT +5'-0" A.F.F TO CENTER LINE OF SIGN (TYPICAL, U.O.N.) - GENDER SYMBOL CORRESPONDING TO SCHEDULED SIGN (FEMALE FIGURE SHOWN) - INTERNATIONAL SIGN OF ACCESSIBILITY - 1" HIGH LETTERS IN YU GOTHIC REPEAT ALL TEXT IN WOMEN CONTRACTED GRADE #2 **BRAILLE**

B2 RESTROOM SIGNAGE- DOORS 111 & 112


A801 3" = 1'-0"

NOTES

SIGN TEXT TO BE RED IN COLOR ON A WHITE REFLECTIVE BACKGROUND (IFC SECTION 509).
 DOOR 105 WILL REQUIRE BOTH SIGNS.
 APPLY SIGN TO SIDE OF DOOR PANEL INDICATED ON FLOOR PLANS.

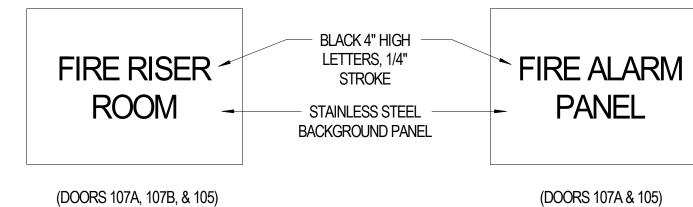

A2 SIGNAGE A801 3" = 1'-0"

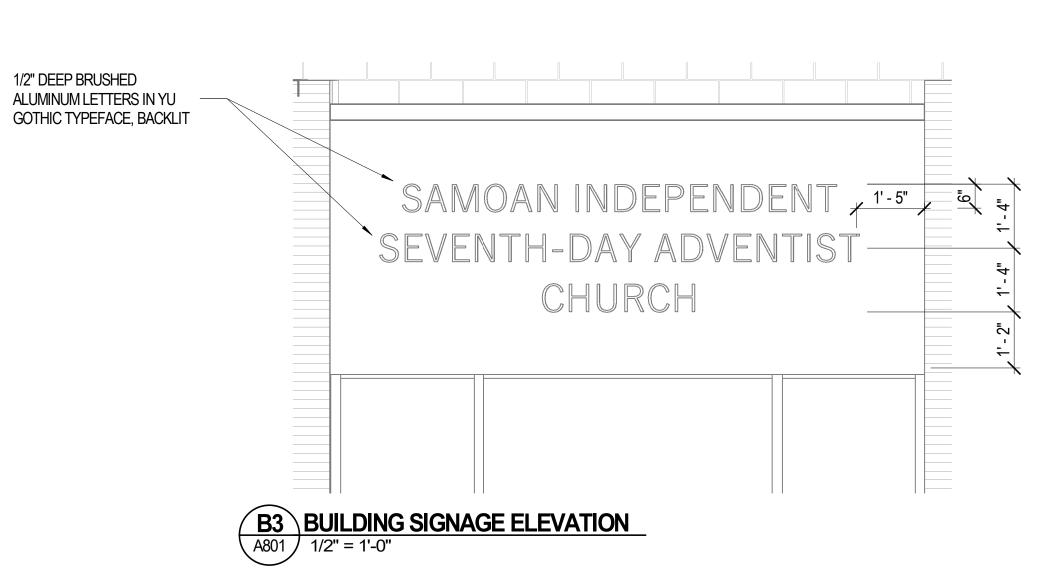

ALL LETTERING TO HAVE

A STANDOFF OF 1" AND

BE BACKLIT

MANUFACTURER RECOMMENDED

STAINLESS STEEL

THREADED FASTENERS

W/ PLUG TO ENSURE

CONDUIT FOR WIRING TO EACH LETTER TO REMOTE MOUNTED

TRANSFORMER/WIRIN

A3 SIGNAGE CONNECTION DETAIL

A801 1/2" = 1'-0"

G ENCLOSURE. TYP.

WATERPROOFFING

CONTINUITY. TYP.

Date Revision 1 2/12/19 CCD 01

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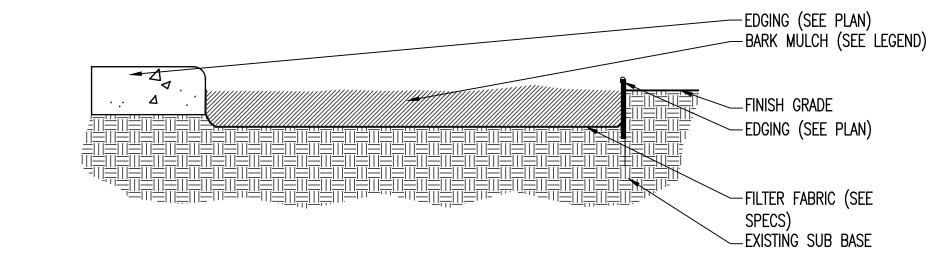
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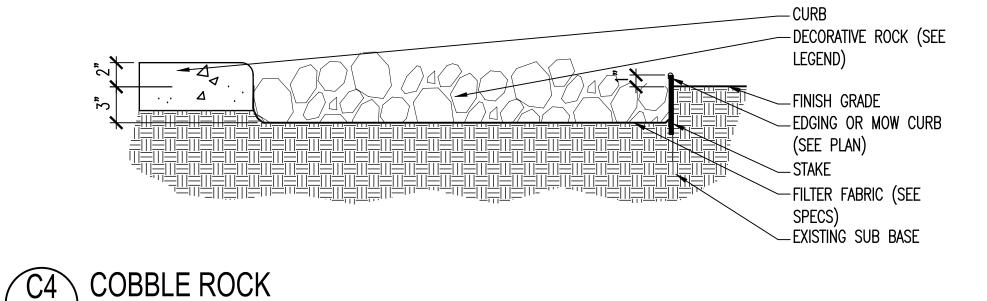
NEXUS PROJECT #: 18030.1 CHECKED BY: Checker DRAWN BY: GEM DATE: 02/17/20

SIGNAGE

A801


-TURF (SEE LP101) -HARDSCAPE (SEE - TOPSOIL -EXISTING SUB GRADE






TOPSOIL DEPTH - TURF LP701 SCALE: 1-1/2" = 1'-0"

> -PLANTER AREA (SEE PLAN) -COBBLE MULCH (SEE PLAN) -MOW CURB —PLANTER TOPSOIL (SEE SPECS) -SUB GRADE

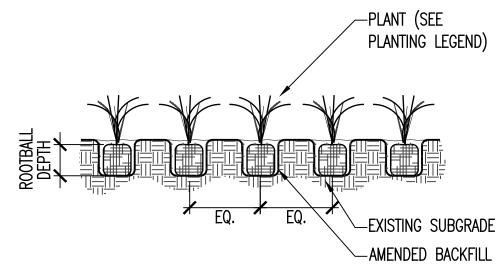


BARK MULCH

SCALE: 1 1/2" = 1'-0"

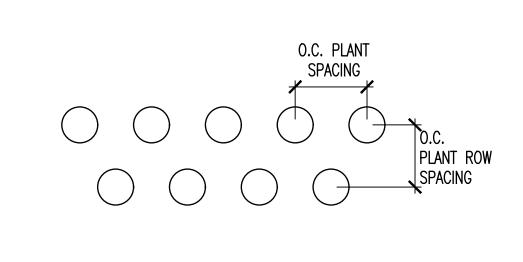

TOPSOIL DEPTH - PLANTER LP701 SCALE: 1-1/2" = 1'-0"

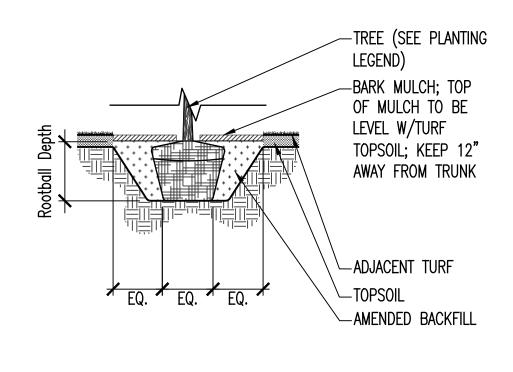


• FOLLOW ALL TREE PLANTING REQUIREMENTS IN DETAILS AND SPECS.

LP701 SCALE: 1/4" = 1'-0"

TREE PLANTING IN TURF AREA

B2 PLANT SPACING LP701 SCALE: 1-1/2" = 1'-0"

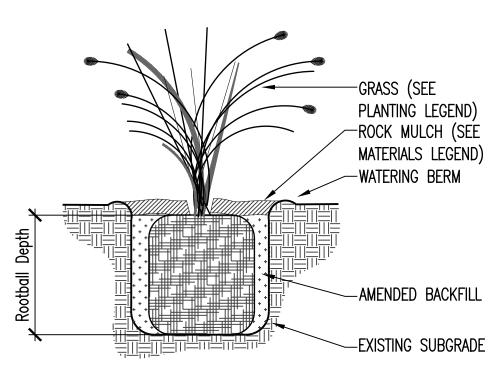

MATERIALS LEGEND) -- WATERING BERM —AMMENDED BACKFILL
SETTLE BY FILLING
ENTIRE PIT W/ WATER SCARIFY ALL PIT SIDES -UNDISTURBED EXISTING SUBGRADE NOTE: WATER PLANT IN POT PRIOR TO REMOVING. DO NOT PLANT DRY PLANTS.

—SHRUB (SEE

←MULCH (SEE

PLANTING LEGEND)

page 33

A2 ORNAMENTAL GRASSES LP701 SCALE: 1" = 1'-0"

A3\ SHRUB ON GRADE LP701 SCALE: 1/2" = 1'-0"

B3 PLANT SPACING

LP701 SCALE: 1-1/2" = 1'-0"

TREE (SEE PLANTING LEGEND) -(2) WOOD TREE STAKES (SEE SPECS) —TREE TIE KIT (SEE SPECS) ─KEEP MULCH 12" AWAY FROM BASE OF TRUNK -ROCK MULCH (SEE MATERIALS LEGEND) —WATERING BERM -FINISH GRADE -AMENDED BACKFILL —SCARIFY ALL PIT SIDES AND BOTTOM EXISTING SUBGRADE

LOCATE TREE STAKES ON OPPOSITES SIDES OF TREE PERPENDICULAR TO PREVAILING WIND.

SCALE: 1 1/2" = 1'-0"

TREE (SEE PLANTING LEGEND) (2) WOOD TREE STAKES TREE TIE KIT (SEE -PLACE TOP OF ROOTBALL 1-2" ABOVE FINISH GRADE. -MULCH (SEE MATERIALS LEGEND) -WATERING BERM -FINISH GRADE -AMENDED BACKFILL -SCARIFY ALL PIT SIDES AND BOTTOM EXISTING SUBGRADE -REMOVE TOP $\frac{1}{2}$ OF BURLAP, WIRE BASKET & TWINE FROM ROOTBALL.

LOCATE TREE STAKES ON OPPOSITE SIDES OF TREE PERPENDICULAR TO PREVAILING WIND.

UPRIGHT EVERGREEN W/ STAKING A5 TREE WITH STAKING LP701 SCALE: 1/4" = 1'-0" LP701 SCALE: 1/4" = 1'-0"



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Date

CONSTRUCTION **DOCUMENTS**

NEXUS PROJECT #: 18030 CHECKED BY: CS DRAWN BY: TS DATE: 02.14.20

LANDSCAPE **DETAILS**

LP701

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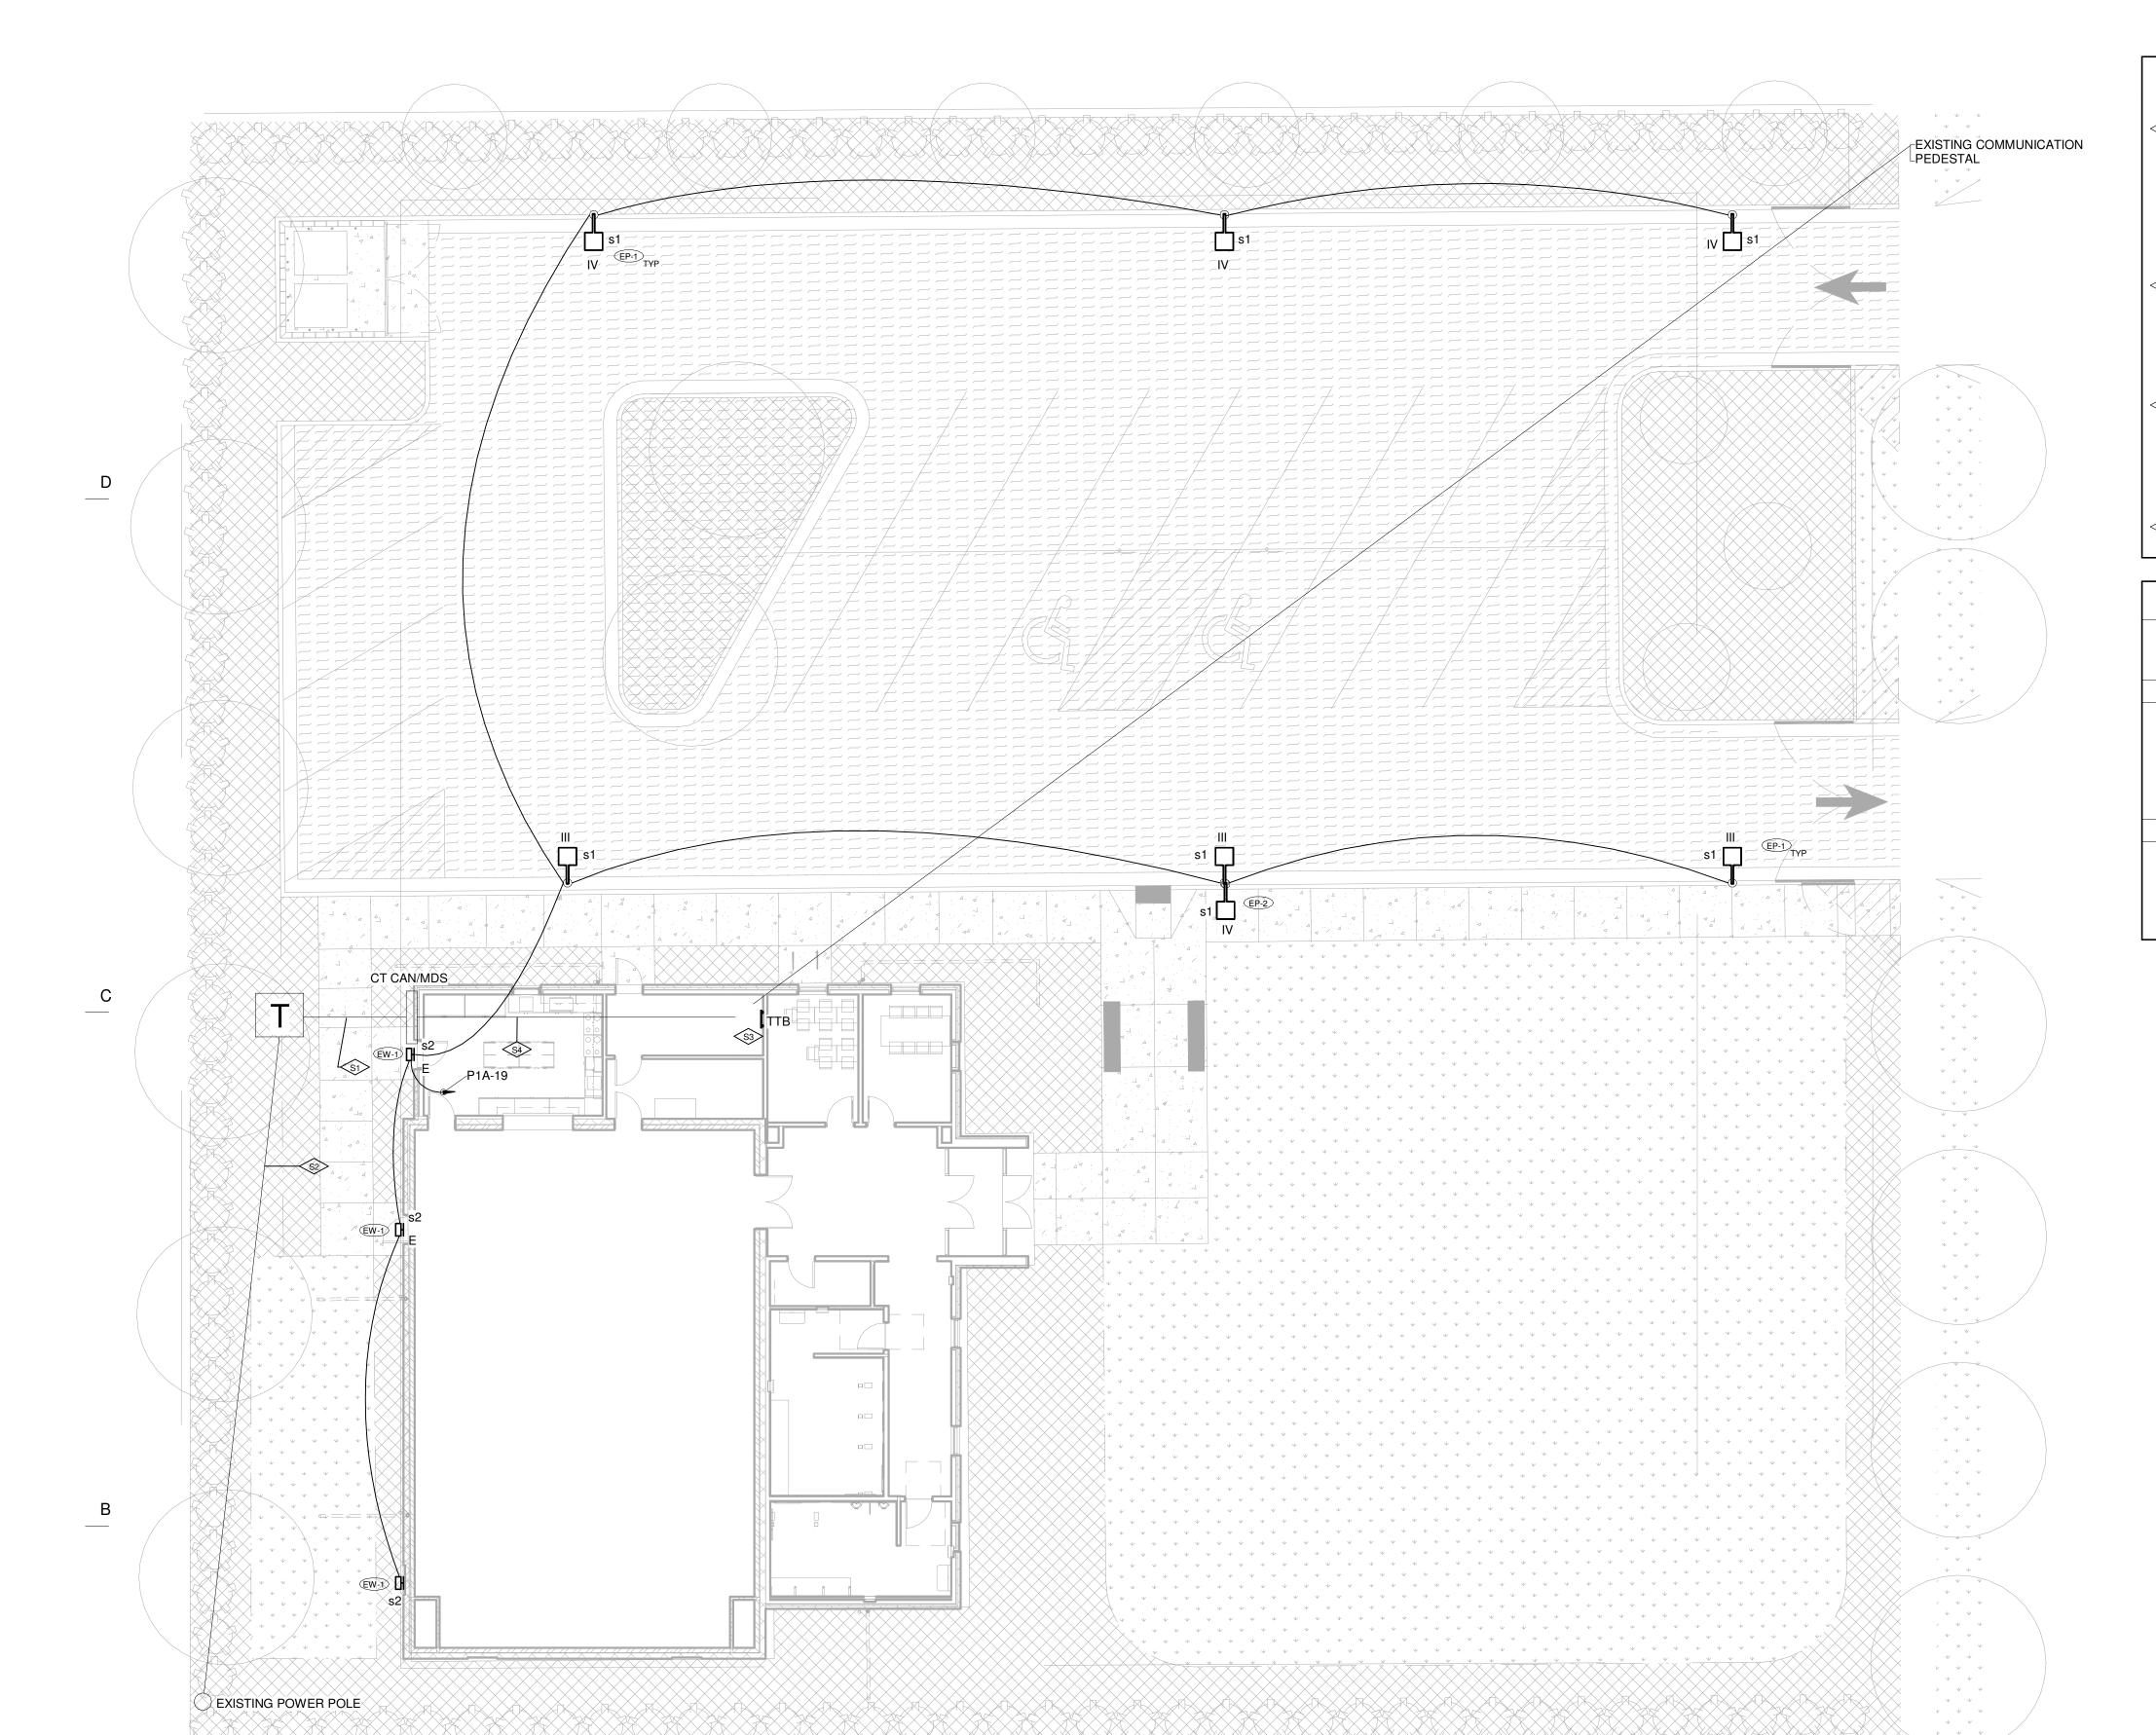
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NEXUS PROJECT #: 18030 CHECKED BY: Checker DRAWN BY: Author DATE: 08/16/21

SITE PLAN -**ELECTRICAL**



REFERENCE NOTES

- S1> RUN (3) 4" PVC CONDUITS WITH PULL STRING 48" BFG (BELOW FINISHED GRADE) FROM THE CT CAN TÓ THE TRANSFORMER. PROVIDE TRENCHING AND BACK FILLING. FIELD VÉRIFY EXACT LOCATION. CONTRACTOR SHALL COORDINATE WITH LOCAL POWER COMPANY PRIOR TO ROUGH-IN TO ENSURE THAT THE LOCATIONS OF THE TRANSFORMER, CT CAN, ETC. MEET LATEST POWER COMPANY REQUIREMENTS. UTILIZE GALVANIZED RIGID ELBOWS. PROVIDE NEW TRANSFORMER PAD TO MEET LOCAL POWER COMPANY'S REQUIREMENTS. REFER TO POWER SINGLE LINE DIAGRAM.
- FURNISH AND INSTALL 4" SCHEDULE 40 PVC CONDUIT WITH PULLSTRING 48" BFG (BELOW FINISHED GRADE) FROM THE TRANSFORMER TO THE EXISTING POWER POLE FOR PRIMARY SERVICE CONDUCTORS. STUB UP CONDUIT SHALL HAVE AN 8" SET BACK FROM EXISTING POWER POLE. PROVIDE TRENCHING AND BACK FILLING. UTILIZE FIBER GLASS LONG SWEEP ELBOWS. COORDINATE THIS WORK WITH LOCAL POWER COMPANY.
- FURNISH AND INSTALL A 4" PVC CONDUIT 36" BFG (BELOW FINISHED GRADE) FROM THE APPROXIMATE LOCATION SHOWN OF TTB TO THE EXISTING COMMUNICATION PEDESTAL. IN ADDITION RUN A 2" CONDUIT WITH PULLSTRING FROM TTB TO COMMUNICATION PEDESTAL FOR CABLE TV. PROVIDE PULLSTRINGS. COORDINATE THIS WORK WITH THE LOCAL COMMUNICATION COMPANY PRIOR TO TRENCHING. PROVIDE TRENCHING AND BACK FILLING.
- S4> RUN A SPARE 4" CONDUIT WITH PULL STRING FROM THE MDS TO THE ELECTRICAL ROOM FOR FUTURE PANEL. CAP AND LABEL BOTH SIDES.

SHEET NOTE - SITE

- 1 TIE ALL FIXTURES INDICATED WITH A LOWER CASE LETTER TO ITS CORRESPONDING SWITCH(ES). PROVIDE CONDUITS, CONDUCTORS, LIGHTING CONTACTORS, ETC. FOR A COMPLÈTE INSTALATION.
- EMERGENCY LIGHT FIXTURES INDICATED WITH THE LETTER "E" (4' SECTION OF LINEAR LIGHT) SHALL BE TIED TO THE EMERGENCY INVERTER AND TURN ON WHEN THE COMMERCIAL POWÉR FAILS REGARDLESS OF THE POSITION OF THE CONTROL SWITCH. THE FIXTURE SHALL BE CONTROLLED BY THE INDICATED SWITCH. PROVIDE CONDUITS, CONDUCTORS, ETC. FOR A COMPLETE INSTALLATION. RUN THE EMERGENCY CIRCUIT IN A SEPARETE RACEWAY. PROVIDE RELAY EQUAL TO BODINE GTD.
- CONTRACTOR IS TO REFER TO THE LIGHTING RELAY SCHEDULES AND PROVIDE PROPER DIMMING WIRES AS REQUIRED (EITHER 0-10 VOLT OR OTHER PROTOCOL SHOWN). DIMMING WIRES SHALL BE RUN IN CONDUIT. COORDINATE WITH THE LIGHTING AND LIGHTING CONTROL SYSTEM SUPPLIER PRIOR TO ROUGH IN TO ENSURE DIMMING MODULES ARE COMPATIBLE WITH THE FIXTURE TYPE

ATTACHMENT C – PROPERTY AND VICINITY PHOTOS



Subject property – View looking west from 1000 W



Existing development adjacent to the subject property to the north



Existing development adjacent to the subject property to the south



Existing development across the street from the subject property



Existing development across the street from the subject property

ATTACHMENT D – RMF-35 ZONING STANDARDS

ADJACENT LAND USES and ZONING

The land use and zoning surrounding the site include the following:

- **North:** RMF-35 contains the Serbian Orthodox Church. Further north is R-2 developed for a variety of residential uses, both single and two-family.
- **South:** RMF-35 residential uses on the same side of the street. On the opposite side of 1000 West to the south zoning changes to CB and across 1700 South the zoning is CG. Along this corridor the uses are more industrial in nature.
- East: R-1/7000 single family residential uses
- West: RMF-35 multi-family residential use

SALT LAKE CITY ZONING ORDINANCE PROVISIONS

21A.24.130: RMF-35 MODERATE DENSITY MULTI-FAMILY RESIDENTIAL DISTRICT:

A. Purpose Statement: The purpose of the RMF-35 Moderate Density Multi-Family Residential District is to provide an environment suitable for a variety of moderate density housing types, including single-family, two-family, and multi-family dwellings with a maximum height of thirty five feet (35'). This district is appropriate in areas where the applicable Master Plan policies recommend a density of less than thirty (30) dwelling units per acre. This district includes other uses that are typically found in a multi-family residential neighborhood of this density for the purpose of serving the neighborhood. Uses are intended to be compatible with the existing scale and intensity of the neighborhood. The standards for the district are intended to provide for safe and comfortable places to live and play, promote sustainable and compatible development patterns and to preserve the existing character of the neighborhood.

Current Zoning Requirements - RMF-35 - Moderate Density Multi-Family Residential District

Zoning Standard	Required	Proposed	Status
Min Lot Area	12,000 SF	1612 S 1000 W- ≈9,583 SF 1624 S 1000 W- ≈26,571 SF Total - ≈36,154 SF	Complies
Min Lot width	140 FT	1612 S 1000 W- 50 FT 1624 S 1000 W- 137.7 FT Total - 187.5 FT	Does not comply - consolidation of the parcels is required before the use can be established. This requirement is noted in the next steps section of the staff report.
Maximum Building Height	35 FT	28 FT	Complies
Front Yard Setback	20 FT	95 FT	Complies

Interior Side Yard	10 FT	10 FT 9 IN on one side and over 95 FT on the other	Complies
Rear Yard	25% of lot depth but not less than 20' and need not exceed 25 FT	25 FT	Complies
Landscape yard required - front	20 FT	95 FT	Complies
Landscape yard required – interior side	10 FT	10 FT	Complies
Maximum building coverage	60% of lot area	Approximately 13%	Complies
Parking Spaces	Minimum 14 standard spaces and 2 ADA spaces Maximum 18 standard spaces and 2 ADA spaces	18 standard spaces and 2 ADA spaces	Complies
	•	4.000	g 1
Interior Parking Lot Landscaping	5% of the interior of the parking lot shall be landscaped in accordance with section 21A.48.070.	628 SF	Complies
	Total Parking Area is 11,343 SF 5% = 567 SF of interior parking lot landscaping required		
Perimeter Parking Lot Landscaping	Landscaped area with at least 7 FT in width. Planting requirements in accordance with 21A.48.070.G.	10 FT wide buffer provided on west side of parking lot and 12 FT wide buffer provided on north side of parking lot	Complies

ATTACHMENT E – CONDITIONAL USE STANDARDS

21A.54.080 Standards for Conditional Use

Approval Standards: A conditional use shall be approved unless the planning commission, or in the case of administrative conditional uses, the planning director or designee, concludes that the following standards cannot be met:

1. The use complies with applicable provisions of this title;

Analysis: The proposed use is located in the RMF-35 (Medium Density Multi Family Residential) zoning district. Per Section 21A.33.020 – Table of Permitted and Conditional Uses for Residential Districts of the Zoning Ordinance, all places of worship in the RMF-35 zone require conditional use approval.

Finding: The proposal complies with the applicable provisions of the Salt Lake City Zoning Ordinance. It is allowed in the zone through the conditional use process and complies with all City requirements for such a facility.

2. The use is compatible, or with conditions of approval can be made compatible, with surrounding uses;

Analysis: Surrounding uses include another place of worship as well as residential uses, both single and multi-family in nature. The proposed use is replacing an established use on the property with the same use but in an upgraded facility. The new facility is expected to continue to work compatibly within the context of its location and the size and scale fit in with the existing development.

Finding: Staff finds that the use and the scale and intensity of development will be compatible with surrounding uses.

3. The use is consistent with applicable adopted city planning policies, documents, and master plans; and

Analysis: The maps in the Westside Master Plan (2014) show that the subject property is located within close proximity to what is envisioned as a smaller regional node near the intersection of 900 West and 1700 South. This node is envisioned to support educational and professional office uses along with supporting commercial retail and services which would act as a transition between residential uses to the north and industrial uses to the south. Up until 2018 when the former church building was demolished, the use was established within the neighborhood. The proposed place of worship is in concert with the Master Plan and the anticipated character of the area over time.

Finding: The use is consistent with applicable adopted city planning policies, documents, and master plans.

4. The anticipated detrimental effects of a proposed use can be mitigated by the imposition of reasonable conditions (refer to Detrimental Impacts Chart below for details).

21a.54.080B Detrimental Effects DeterminationIn analyzing the anticipated detrimental effects of a proposed use, the planning commission shall determine compliance with each of the following:

Criteria	Finding	Rationale
1. This title specifically authorizes the use where it is located	Complies	A place of worship such as a church is allowed as a conditional use in the RMF-35 zoning district.
2. The use is consistent with applicable policies set forth in adopted citywide, community, and small area master plans and future land use maps	Complies	The Westside Master Plan recognizes that places of worship across many faiths are distributed throughout neighborhood areas and are part of the assets and resources of the community. The proposed use is in concert with the Master Plan.
3. The use is well-suited to the character of the site, and adjacent uses as shown by an analysis of the intensity, size, and scale of the use compared to existing uses in the surrounding area	Complies	The surrounding area includes a mix of multi and single-family residential uses as well as another church immediately to the north of the subject property. The mass and scale is compatible with what could be potentially built by right in the RMF-35 zoning district.
4. The mass, scale, style, design, and architectural detailing of the surrounding structures as they relate to the proposed have been considered	Complies	As discussed above, the scale of the proposal is compatible with surrounding structures. The proposed church is approximately 30-feet tall, which is less than the maximum height allowed in the zoning district. The proposed design does not maximize the allowable height or maximize the site coverage. As such, it will fit in with the existing development in the area in terms of mass and scale.
5. Access points and driveways are designed to minimize grading of natural topography, direct vehicular traffic onto major streets, and not impede traffic flows	Complies	There are 3 existing access drives onto 1000 West from the property. The 3 rd access drive is located to the south of the church and is unused. It will be abandoned and the curb cut will be replaced with curb and gutter and landscaping. The access points and driveway will not impede traffic flows.
6. The internal circulation system is designed to mitigate adverse impacts on adjacent property from motorized, non-motorized, and pedestrian traffic	Complies	The internal site circulation includes an entrance and exit driveway which will allow traffic to flow through the parking area smoothly. There are no anticipated detrimental impacts on adjacent properties from the internal circulation on this site.
7. The site is designed to enable access and circulation for pedestrian and bicycles	Complies	There is existing sidewalk on 1000 W, part of which will be replaced with this project that will provide pedestrian access to the site. In addition, the Transportation Division has indicated that one bicycle rack will be required on the site. The site will enable access for both pedestrians and bicycles.

	- 4	ml
8. Access to the site does not unreasonably impact the service level	Complies	The proposed use is anticipated to be low volume in nature and will not impact the
of any abutting or adjacent street		service levels on 1000 West. On the subject
		property, it is recommended by Engineering that the property owner replace the public
		sidewalk along 1000 West which is in poor
		condition.
9. The location and design of off-street	Complies	The proposed parking consists of 18 standard parking stalls and 2 ADA accessible
parking complies with applicable standards of this code		spaces. Based on the building floor area for
standards of this code		congregation space, offices space and gym, a
		minimum of 14 parking spaces and 2 ADA accessible spaces would be required. The
		RMF-35 zoning district would allow for
		parking that is 25% greater than the
		minimum. The parking meets the maximum parking allowed in the zone. Additionally, the
		parking lot interior and perimeter parking lot
		landscaping exceeds the requirements of the 21A.48.070.
10. Utility capacity is sufficient to	Complies	The site is within a developed area with all
support the use at normal service levels	GG p G	utility infrastructure in place. The site
		currently has both water and sewer service. Salt Lake City Public Utilities has been
		involved in the review process and will work
		through the building permit process to
		ensure that the utility infrastructure is adequate for the proposed facility. A utility
		plan will need to be submitted for review and
		compliance will be ensured during the
11. The use is appropriately screened,	Complies	building permitting process. The proposed landscaping buffers meet the
buffered, or separated from adjoining	GG p GG	requirements of the RMF-35 zoning district
dissimilar uses to mitigate potential		and the parking lot landscaping requirements in 21A.48.070.
use conflicts		•
12. The use meets City sustainability	Complies	There is no indication that the proposed project will introduce any environmental
plans, does not significantly impact the quality of surrounding air and water,		damage to the surrounding area.
encroach into a river or stream, or		
introduce any hazard or environmental		
damage to any adjacent property,		
including cigarette smoke		A gide from Cumdou gowies hours the shunch
13. The hours of operation and delivery of the use are compatible with	Complies	Aside from Sunday service hours, the church will host activities throughout the week as
surrounding uses		part of their programming for congregation
3		members. The anticipated hours of normal operation will be compatible with
		surrounding uses.
14. Signs and lighting are compatible	Complies	Any signs and lighting will be confined to
with, and do not negatively impact	•	that necessary to provide safety on the site
surrounding uses		including for adequate security while being minimized in order to not impact adjacent
		properties.

15. The proposed use does not	Complies	The property is not located within a Local
undermine preservation of historic resources and structures		Historic District and the proposal does not involve removal or any historic resources or structures.

Finding: In analyzing the anticipated detrimental effects of the proposed use, Staff finds the request complies with the criteria listed above.

ATTACHMENT F – PUBLIC PROCESS & COMMENTS

Public Notice, Meetings, Comments

The following is a list of public meetings that have been held, and other public input opportunities, related to the proposed project since the applications were submitted:

- Recognized Organization Notification June 1, 2021 Notice of the project was provided to the Glendale Community Council. The 45-day noticing period to request the project be presented at a Community Council meeting expired July 16, 2021. As of the publication of the staff report, no comments from the community council have been received.
- Early Notification June 3, 2021 Early notification of the project was provided to property owners and residents within 300 FT of the proposed conditional use. As of the publication of the staff report, no comments from property owners or residents within 300 FT of the proposal have been received.
- <u>City Open House June 14, 2021</u> Staff hosted an online Open House to solicit public comments on the proposal. The Online Open House period started on June 14, 2021 and ended on July 16, 2021.

Notice of the public hearing for the proposal included:

Public hearing notice mailed on August 12, 2021 Public hearing notice posted on August 13, 2021 Public notice Planning Division list serve on August 12, 2021

Public Input:

As of the publication of the staff report, no public comments or inquiries have been received in regard to the proposed conditional use.

If any comments are received after publication of the Staff Report, they will be forwarded to the Commission and included in the public record.

ATTACHMENT H – DEPARTMENT REVIEW COMMENTS

Engineering: (Scott Weiler at scott.weiler@slcgov.com or 801-535-6159)

No objections to Conditional Use. It is recommended that the badly cracked public sidewalk in 1000 West be replaced as part of this project. Any work performed in the public right of way would require a contractor who is licensed, bonded, and insured and has the documentation on file with Salt Lake City Engineering to obtain a permit to work in the public right of way from the SLC Engineer's office.

Transportation: (Michael Barry at <u>michael.barry@slcgov.com</u> or 801-535-7147)

The minimum parking requirement for places of worship is 1 space per 1,000 sf. The parking calculations are shown on sheet 9, 25 and 30. On sheets 9 and 30, they use 3 spaces per 1,000 sf and on sheet 25, they use 1 space per 1,000 sf; this discrepancy needs to be resolved. The discrepancy may be because the assembly room doubles as a gym. I would go with the use that requires the most parking to be conservative which puts the minimum at 16 stalls. The maximum parking allowance is 25% more than the required minimum (therefore 20 stalls) and in this case the number of spaces provided (23 stalls) exceeds the maximum allowance. The maximum allowance can be increased by 21A.44.050.C.3 Transportation Demand Management Parking Incentives. The parking layout is acceptable; the driveways, since they were existing, are acceptable even though they are not separated by 100 feet.

Public Utilities: (Jason Draper at jason.draper@slcgov.com)

- Utilities to the neighboring property go through this property. Easements and protection of these utilities is required.
- Minimum separation requirements must be met. 10' between water and sewer. 5' from sewer to all other utilities and buildings and property lines. 3' from water to all other utilities. 5' from water to buildings and property lines. Water meters must have 5' clearance around the meter.
- Utilities cannot cross property lines without appropriate easements and agreements.
- All utility design and construction must comply with APWA Standards and SLCPU Standard Practices.

Fire: (Ted Itchon 801-535-6636 or <u>ted.itchon@slcgov.com</u>) No comments provided.